MOLLIDGEWOCK STATE PARK

NEW VISITORS RECEPTION CENTER - 80% DESIGN

1437 Berlin Road Errol, NH 03570

SHEET LIST

S1.01

SHEET NO.	SHEET TITLE
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C1.00	EXISTING CONDITIONS
C1,01	DEMOLITION PLAN
C2.00	SITE PLAN
C3.00	EROSION CONTROL DETAILS
C3.01	CIVIL DETAILS
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P1.02IVI	PLUMBING PLAN AND DETAILS
P1.01M P1.02M	PLUMBING PLAN AND DETAILS PLUMBING PLAN AND DETAILS
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A1.01	WOODSHED FLOOR AND ROOF PLANS
A2.01	WOODSHED EXTERIOR ELEVATIONS
A3.01	WOODSHED SECTIONS

WOODSHED FOUNDATION AND ROOF FRAMING PLANS AND DETAILS

SITE



NH STATE PARKS

ISE GROUP

tel: 802.862.0098 fax: 802.865.2440 www.segroup.com

Campground Expansion Project PII Mollidgewock State Park 1437 Berlin Road Errol, NH

80% DESIGN Graphic Scale

Date: November 30, 2023

Drawn By: KS

No.	Description	Date
1	Name	00/00/00

COVER SHEET

G0.00


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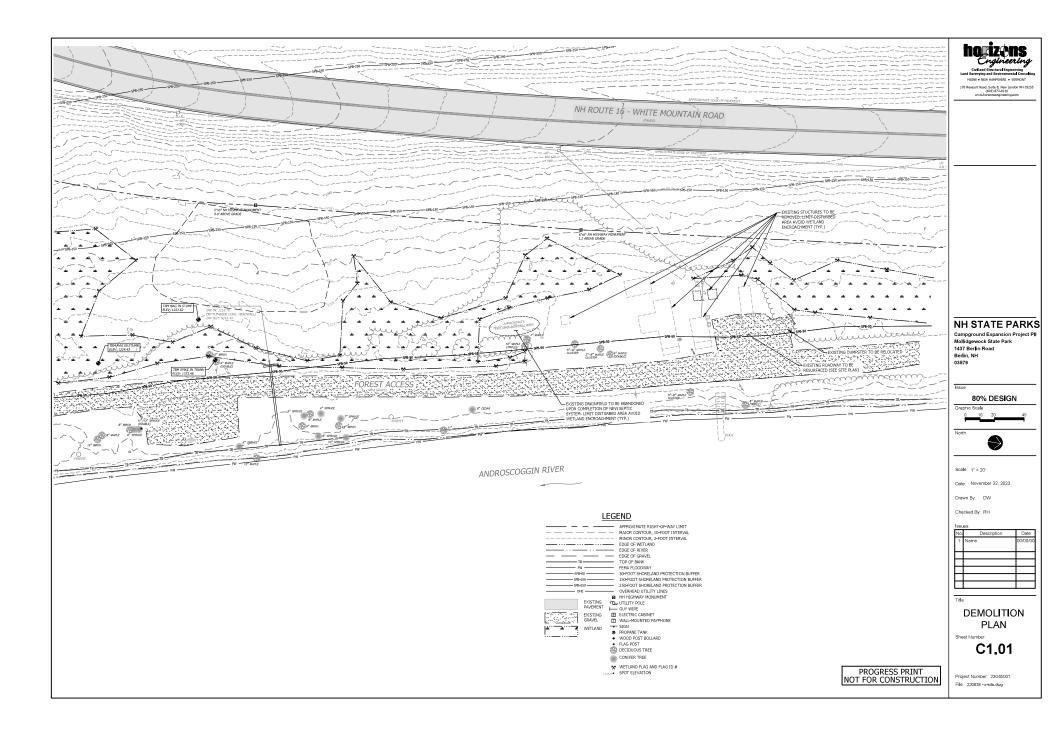
LANDSCAPE ARCHITECT CIVIL ENGINEER SE GROUP 1 MILL STREET, SUITE 190


HORIZONS ENGINEERING 176 NEWPORT ROAD, SUITE 8 BURLINGTON VT 05401 NEW LONDON NH 03257

ARCHITECT SAMYN-D'ELIA ARCHITECTS, P.A. CPB & ASSOCIATES 6 CENTRAL HOUSE ROAD HOLDERNESS, NH 03245

ELECTRICAL 500 DEPOT STREET RUMNEY NH 03266



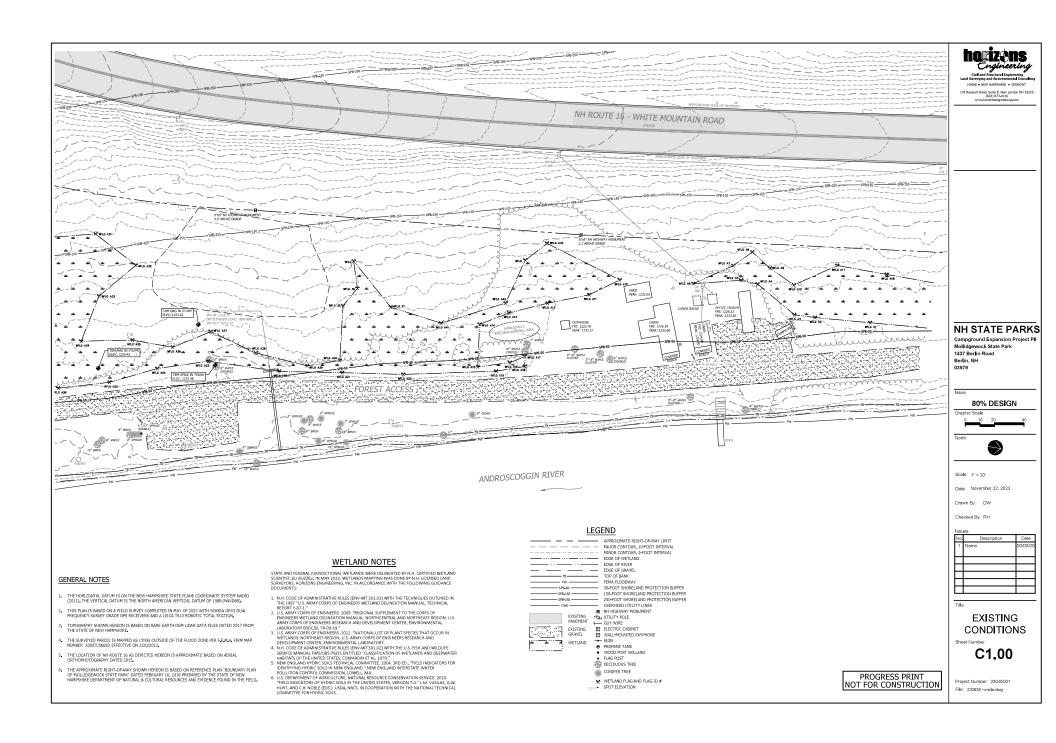

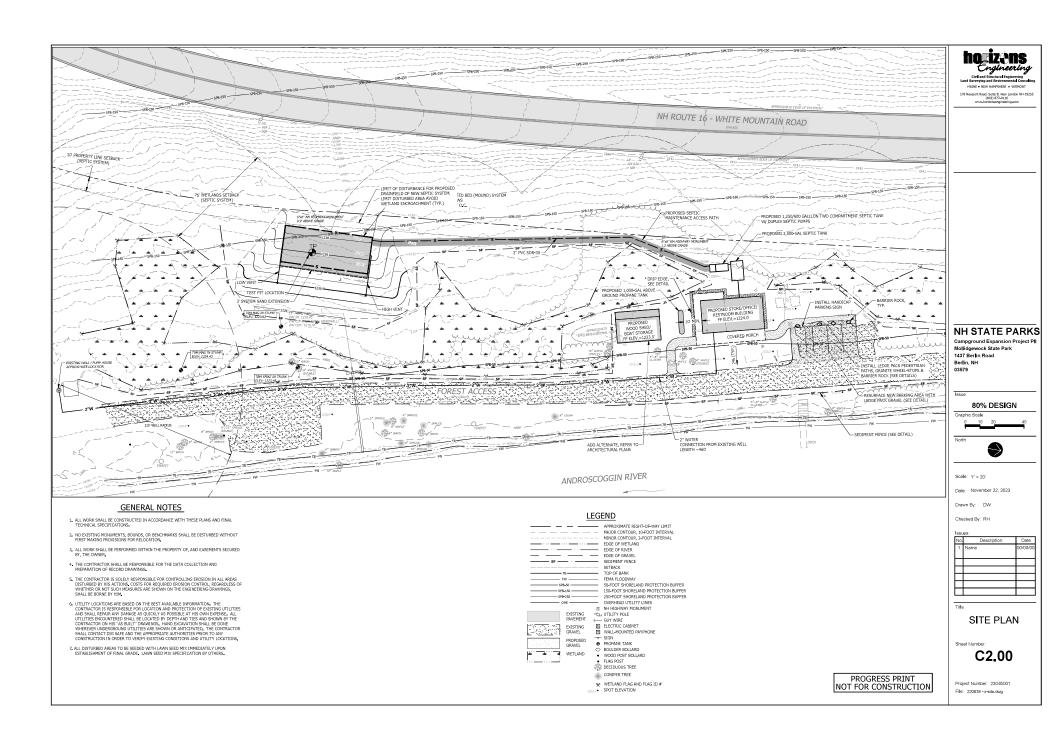

SEEDING RECOMMENDATIONS

GRADING AND SHAPING
A SLOPES SHALL NOT BE STEEPER THAN 2:1; 3:1 SLOPES OR FLATTER ARE PREFERRED, WHERE MOWING WILL BE DONE, 3:1 SLOPES OR FLATTER ARE RECOMMENDED.

2. SEEDBED PREPARATION

A SURFACE AND SEEPING WATER SHOULD BE DRAINED OR DIVERTED FROM THE SITE TO PREVENT DROWNING OR WINTER KILLING OF THE PLANTS.

B. STONES LARGER THAM 4 INCHES AND TRACH SHOULD BE REMOVED BECAUSE THEY INTERFERE WITH SECOND AND FURTHER MAINTENANCE OF THE AREA, WEREE FRESHEE, THE SOIL SHOULD BE AMENDED WITH DOGGMENT WATTER MAINTENANCE TO REPORT A REPORT OF A DEPTH OF A DOGGMENT OF A STONES TO A DEPTH OF A DOGGMENT OF A STONES OF A DOGGMENT OF A STONES OF A DOGGMENT OF A STONES OF A DOGGMENT OF A DOGGMEN

ESTABLISHING VEGETATION
 A. LIME AND FERTILIZES SHOULD BE APPLIED PRIOR TO OR AT THE TIME OF SEEDING AND INCORPORATED IN
THE SOIL. INIDS AND AMOUNTS OF LIME AND FERTILIZER SHOULD BE BASED ON AN EVALUATION OF SOIL
TESTS. WHEN A SOIL TEST IS NOT AVAILABLE, THE FOLLOWING MINIMUM AMOUNTS SHOULD BE APPLIED:

-AGRICULTURAL LIMESTONE, 2 TONS PER ACRE OR 100 LBS. PER 1,000 SO, FT.
-MITROGEN (N), SO LBS. PER ACRE OR 1 LLES, PER 1,000 SO, FT.
-PHOESPHATE (P.O.), 100 LBS. PER ACRE OR 2.2 LBS. PER 1,000 SO, FT.
-POTASH (K,O), 100 LBS. PER ACRE OR 2.2 LBS. PER 1,000 SO, FT.

(NOTE: THIS IS THE EQUIVALENT OF 500 LBS. PER ACRE OF 10-20-20 FERTILIZER OR 1,000 LBS. PER ACRE OF 5-10-10).

B. SEED SHOULD BE SPREAD UNIFORMLY BY THE METHOD MOST APPROPRIATE FOR THE SITE. METHODS INCLUDE BROADCASTING, DRILLING, AND HYDROSEEDING. WHERE BROADCASTING IS USED, COVER SEED WITH .25 INCH OF SOLIO RLESS, BY CULTIPACKING OR RAYING.

•	SEEDI	NO	OU	DE:

	SEEDING		SOIL TYPE		
USE	MIXTURE (SEE 3D)	DROUGHTY	DRAINED	MOD, WELL DRAINED	POORLY DRAINED
STEEP CUTS AND FILLS, BORROW AND DISPOSAL AREAS	A B C	FAIR POOR FAIR	GOOD GOOD EXCELLENT	GOOD FAIR EXCELLENT	FAIR FAIR POOR
WATERWAYS, EMERGENCY SPILL- WAYS, AND OTHER CHANNELS WITH FLOWING WATER	A	G00D	GOOD	GOOD	FAIR
LIGHTLY USED PARKING LOTS, ODD AREAS, UNUSED LANDS, AND LOW INTENSITY USE RECREATION SITES	A B	GOOD GOOD	GOOD	GOOD FAIR	FAIR POOR

	MDCTURE	PER ACRE	1,000 SQ. FT
A	TALL FESCUE CREEPING RED FESCUE REDTOP TOTAL:	20 20 2 42	0.45 0.45 0.05 0.95
В	TALL FESCUE CREEPING RED FESCUE CROWN VETCH OR FLATPEA TOTAL:	15 10 15 OR 30 40 OR 55	0.35 0.25 0.35 OR 0.75 0.95 OR 1.3
С	TALL FESCUE FLATPEA TOTAL:	20 30 50	0.45 0.75 1.20

E. WHEN SEEDED AREAS ARE MULCHED, PLANTINGS MAY BE MADE FROM EARLY SPRING TO SEPTEMBER 15. WHEN SEEDED AREAS ARE NOT MULCHED, PLANTINGS SHOULD BE MADE FROM EARLY SPRING TO MAY 20 OR FROM JULIST 10 TO SEPTEMBER 1.

Ρ,	F. TEMPORARY SEEDING RATES:				
	SPECIES	POUNDS PER ACRE	POUNDS PER 1,000 SQ. FT.	REMARKS	
	WINTER RYE	112	2,5	BEST FOR FALL SEEDING, SEED FROM AUGUST TO SEPTEMBER STH FOR BEST COVER. SEED TO A DEPTH OF 1 INCH.	
	OATS	80	2.0	BEST FOR SPRING SEEDING. SEED NO. LATER THAN MAY 15TH FOR SUMMER. PROTECTION. SEED TO A DEPTH OF 1. INCH.	
	ANNUAL RYEGRASS	40	1,0	GROWS QUICKLY, BUT IS OF SHORT DURATION. USE WHERE APPEARANCES ARE NOT IMPORTANT. SEED EARLY SPRING AMOJOR BETWEEN AUGUST 15TH AND SEPTEMBER LISTH COVER SEED WITH NO MORE THAN 0.25 INCH OF SOIL.	
	PERENNIAL RYEGRASS	30	0.7	GOOD COVER WHICH IS LONGER LASTING THAN ANNUAL RYEGRASS, SEED BETWEEN APRIL 1ST AND JUNE IST AND/OR BETWEEN AUGUST 1STH AND SEPTEMBER 1STH, MULCHING WILL ALLOW SEEDING THROUGHOUT THE GROWING SEASON, SEED TO A DEPTH OF APPROXIMATELY OS, INCH.	


MULCH
 A. HAY, STRAW, OR OTHER MULCH, WHEN NEEDED, SHOULD BE APPLIED IMMEDIATELY AFTER SEEDING.

B. MULCH WILL BE HELD IN PLACE USING APPROPRIATE TECHNIQUES FROM THE BEST MANAGEMENT PRACTICE FOR MULCHING.

MAINTENANCE TO ESTABLISH A STAND
 A PLANTED AREAS SHOULD BE PROTECTED FROM DAMAGE BY FIRE, GRAZING, TRAFFIC, AND DENSE WEED
GROWTH.

B. FERTILIZATION NEEDS SHOULD BE DETERMINED BY ON SITE INSPECTIONS. SUPPLEMENTAL FERTILIZER IS USUALLY THE KEY TO FULLY COMPLETE THE ESTABLISHMENT OF THE STAND BECAUSE MOST PERENNIALS TAKE 2 TO 3 YEARS TO BECOME STRAILISHED.

C. IN WATERWAYS, CHANNELS, OR SWALES WHERE UNIFORM FLOW CONDITIONS ARE ANTICIPATED, OCCASIONAL MOWING MAY BE NECESSARY TO CONTROL GROWTH OF WOODY VEGETATION.

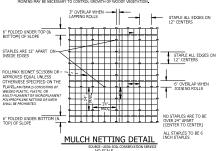

EROSION CONTROL GENERAL NOTES

A. KEEP SITE MODIFICATION TO A MINIMUM

1. CONSIDER FITTING THE BUILDINGS AND STREETS TO THE NATURAL TOPOGRAPHY. THIS REDUCES THE NEEP FOR CUTS AND FILLS. AVOID EXTENSIVE GRADING THAT WOULD ALTER DRAINAGE PATTERNS OR CREATE VERY STEEP SLOPES.

2. EXPOSE AREAS OF BARE SOIL TO EROSIVE ELEMENTS FOR THE SHORTEST TIME POSSIBLE.

- SAVE AND PROTECT DESIRABLE EXISTING VEGETATION WHERE POSSIBLE. ERECT BARRIERS
 TO PREVENT DAMAGE FROM CONSTRUCTION EQUIPMENT.
- LIMIT THE GRADES OF SLOPES SO VEGETATION CAN BE EASILY ESTABLISHED AND MAINTAINED.
- 5. AVOID SUBSTANTIAL INCREASE IN RUNOFF LEAVING THE SITE.

B. MINIMIZE POLLUTION OF WATER DURING CONSTRUCTION ACTIVITIES 1. STOCKPILE TOPSOIL REMOVED FROM CONSTRUCTION AREA AND SPREAD OVER ANY DISTURBED AREAS PRIOR TO REVEGETATION. TOPSOIL STOCKPILES MUST BE PROTECTED FROM BROSION.

- PROTECT BARE SOIL AREAS EXPOSED BY GRADING ACTIVITIES WITH TEMPORARY VEGETATION OR MULCHES.
- USE SEDIMENT BASINS TO TRAP DEBRIS AND SEDIMENT WHICH WILL PREVENT THESE MATERIALS FROM MOVING OFF SITE.
- USE DIVERSIONS TO DIRECT WATER AROUND THE CONSTRUCTION AREA AND AWAY FROM EROSION PRONE AREAS TO POINTS OF SAFE DISPOSAL.
- 5. USE TEMPORARY CULVERTS OR BRIDGES WHEN CROSSING STREAMS WITH EQUIPMENT.
- PLACE CONSTRUCTION FACILITIES, MATERIALS, AND EQUIPMENT STORAGE AND MAINTENANCE AREAS AWAY FROM DRAINAGE WAYS.

- C. PROTECT AREA AFTER CONSTRUCTION.

 1. ESTABLISH GRASS OR OTHER SUITABLE VEGETATION ON ALL DISTURBED AREAS. SELECT SPECIES ADAPTED TO THE SITE CONDITIONS AND THE FUTURE USE OF THE AREA. FINAL GRADES SHALL BE SEEDED WITHIN 72 HOURS. STABILIZATION SHALL BE DEFINED AS 85%
- MAINTAIN VEGETATED AREAS USING PROPER VEGETATIVE BEST MANAGEMENT PRACTICES DURING THE CONSTRUCTION PERIOD.
- MAINTAIN NEEDED STRUCTURAL 'BEST MANAGEMENT PRACTICES' AND REMOVE SEDIMENT FROM DETENTION PONDS AND SEDIMENT BASINS AS NEEDED.
- DETERMINE RESPONSIBILITY FOR LONG TERM MAINTENANCE OF PERMANENT 'BEST MANAGEMENT PRACTICES'.
- IF CONSTRUCTION IS ANTICIPATED DURING WINTER MONTHS, REFER TO 'COLD WEATHER SITE STABILIZATION REQUIREMENTS'

D. INVASIVE SPECIES AND FIGURITY DUST

1. THE PROJECT SHALL NOT CONTRIBUTE TO THE SPREAD OF INVASIVE SPECIES, PRIOR TO
CONSTRUCTION, THE CONTROCTOR SHALL TAKE MICESSARY MEASURES TO REQUIT THEIR
INVASIVE SPECIES, AND IF FOUND SHALL TAKE INCESSARY MEASURES TO REQUIT THEIR
THE PRIOR OF THE PROJECT OF THE REPORT THE REPORT OF THE PROJECT OF A PRIOR TO THE PROJECT OF T

2. FUGITIVE DUST SHALL BE CONTROLLED IN ACCORDANCE WITH ENV-A 1000.

CONSTRUCTION NOTES

COLD WEATHER SITE STABILIZATION REQUIREMENTS


TO ADEQUATELY PROTECT WATER QUALITY DURING COLD WEATHER AND DURING SPRING RUNOFF, THE FOLLOWING ADDITIONAL STABILIZATION TECHNIQUES SHALL BE EMPLOYED DURING THE PERIOD FROM OCTOBER 15 THROUGH MAY 1:

- THE AREA OF EXPOSED, UNSTABILIZED SOIL SHALL BE LIMITED TO 1 ACRE AND SHALL BE PROTECTED AGAINST ERGOLON BY THE METHODS DESCRIBED IN THIS SECTION PRIOR TO ANY THAW OR SPRING MELT EVENT. THE ALLOWABLE AREA OF EXPOSED SOIL MAY BE INCREASED IF A WINTER CONSTRUCTION FLAN, DEVELOPED BY A QUALIFIED ENGINEER OR A CPESC SPECIALIST. IS REVIEWED AND APPROVED BY NHDES.
- 2. ALL PROPOSED VEGETATED AREAS HAVING A SLOPE OF LESS THAN 15% WHICH DO NOT EXHIBIT A MINIMUM OF 85% VEGETATIVE GROWTH BY OCTOBER 15, OR WHICH ARE DISTURBED AFFEC OCTOBER 15, SHALL BE SEEDED AND COVERED WITH 3 TO 4 TONS OF HAY OR STRAW MULCH FER ACRE, SECURED WITH ANCHORED NETTING OR TACKIFIER, OR 2 INCHES OF EROSION CONTROL MIX MEETING THE CRITERIA OF ENV-WQ 1506.05(D) THROUGH (H)
- 3. ALL PROPOSED VEGETATED AREAS HAVING A SLOPE OF GREATER THAN 15% ALL PREVISED YESSER ALLD MICHS HAVING A SLUDE OF GREATER IN HIM 15% WHICH DO NOT SHEBIT A MINIMUM OF 95% VEGETATIVE GROWTH BY OCTOBER 15, OR WHICH ARE DISTURBED AFTER OCTOBER 15, HALL SEEDED AND COVERED WITH PROPERLY INSTALLED AND ANA-ORDE EROSION CONTROL MIX METHOD OR WITH A MINIMUM A HICH TRICKIESS OF EROSION CONTROL MIX MEETING THE CULTERA OF ENWAYQ 150C(6)(1) THROUGH (H)
- 4. INSTALLATION OF ANCHORED HAY MULCH OR EROSION CONTROL MIX, MEETING
- 5. INSTALLATION OF EROSION CONTROL MATTING SHALL NOT OCCUR OVER SNOW PROTECTIVE OF GREATER THAN ONE INCH IN DEPTH OR ON FROZEN GROUND.

 STATEMAN OF THE STATEM
- ALL PROPOSED STABILIZATION IN ACCORDANCE WITH NOTES 2 OR 3 ABOVE SHALL BE COMPLETED WITHIN 1 DAY OF ESTABLISHING THE GRADE THAT IS FINAL OR THAT OTHERWISE WILL EXIST FOR MORE THAN 5 DAYS.
- ALL DITCHES OR SWALES WHICH DO NOT EXHIBIT A MINIMUM OF 85% VECETATIVE GROWTH BY OCTOBER 15, OR WHICH ARE DISTURBED AFTER OCTOBER 15, SHALL BE STABLIZED TEMPORABLY WITH STONE OR REGISTON COMPROL BLANKETS APPROPRIATE FOR THE DESIGN FLOW CONDITIONS, AS DETERMINED BY THE CONVERSE SMIKERING CONSULTANT.
- 8. AFTER OCTOBER 15, INCOMPLETE ROAD OR PARKING AREAS WHERE ACTIVE CONSTRUCTION OF THE ROAD OR NORKING AREA HAS STOPPED FOR THE WINTER SEASON SHALL BE PROTECTED WITH A MINIMUM 3 INCH LAYER OF BASE COURSE GRAVELS MEETING THE GRADATION REQUIREMENTS OF INDIOT STANDARD SPECIFICATION FOR ROAD AND BRIDGE CONSTRUCTION, 2016, ITEM

LEVEL LIP SPREADER INSTALLATION

- CONSTRUCT THE LEVEL SPREADER LIP ON A ZERO PERCENT GRADE TO INSURE UNIFORM SPREADING OF RUNOFF.
- 2. LEVEL SPREADER SHALL BE CONSTRUCTED ON UNDISTURBED SOIL AND NOT ON
- AN EROSION STOP SHALL BE PLACED VERTICALLY A MINIMUM OF SIX INCHES DEEP IN A SLIT TRENCH ONE FOOT BACK OF THE LEVEL LIP AND PARALLEL TO THE LIP. THE EROSION STOP SHALL EXTEND THE ERVIRSE LENGTH OF THE LEVEL LIP.
- THE ENTIRE LEVEL LIP AREA SHALL BE PROTECTED BY PLACING TWO STRIPS OF JUTE OR EXCELSIOR MATTING ALONG THE LIP. EACH STRIP SHALL OVERLAP THE EROSION STOP BY AT LEAST SIX INCHES.
- THE ENTRANCE CHANNEL TO THE LEVEL SPREADER SHALL NOT EXCED A 1 PERCENT GRADE FOR AT LEAST 50 FEET BEFORE ENTERING INTO THE SPREADER.
- THE FLOW FROM THE LEVEL SPREADER SHALL OUTLET ONTO STABILIZED AREAS WATER SHOULD NOT RE-CONCENTRATE IMMEDIATELY BELOW THE SPREADER.
- 7. PERIODIC INSPECTION AND REQUIRED MAINTENANCE SHALL BE PERFORMED.
- 8. PROTECTIVE MATERIAL AND EROSION STOP SHALL BE NORTH AMERICAN GREEN C125 EROSION CONTROL BLANKET OR APPROVED EQUAL.

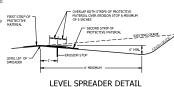

NO SCALE

SOURCE: ROCKINGHAW COUNTY CONSERVATION SERVICE

CONSTRUCTION SEQUENCE

- PREPARE AN EROSION CONTROL PLAN OR A STORMWATER POLLUTION PREVENTION PLAN (SWPPP) IN ACCORDANCE WITH LOCAL, STATE, AND FEDERAL REQUIREMENTS.
- 2. INSTALL CONSTRUCTION ENTRANCE, SEE DETAIL.
- 3. CUT AND CLEAR TREES WITHIN THE CLEARING LIMITS.
- 4. INSTALL SEDIMENT FENCES, ROCK CHECK DAMS, AND OTHER APPROPRIATE EROSION CONTROL MEASURES AT LOCATIONS SHOWN ON THE PLANS AND AS NEEDED.
- 5. GRUB SITE WITHIN GRADING LIMITS.
- 6. STRIP AND STOCKPILE TOPSOIL AND INSTALL EROSION CONTROL MEASURES.
- INSTALL/ADJUST SEDIMENT FENCE, CHECK DAMS, AND HAYBALES, AS REQUIRED.
- CONSTRUCT PERMANENT STORMWATER CONTROLS AS SOON AS PRACTICAL
 DO NOT DIRECT STORMWATER TOWARD TREATMENT BASINS, PONDS, SWALES
 DITCHES AND LEVEL SPREADERS UNTIL THEY HAVE BEEN STABILIZED.
- PROCEED WITH WORK, LIMITING THE DURATION OF DISTURBANCE. THE MAXIMUM OF UNCOVERED DISTURBED EARTH AT ANY ONE TIME IS FIVE ACRES. THE MAXIMUM LEWISTH OF TIME THAT DISTURBED EARTH MAY BE LEFT UNSTABILIZED IS 45 DAYS.

 BEGIN SEEDING AND MULCHING IMMEDIATELY AFTER GRADING. ALL DISTURBED AREAS SHALL BE STABILIZED WITH APPROVED METHODS WITHIN 72 HOURS OF ACHIEVING FINISHED GRADE. AN AREA SHALL BE CONSIDERED STABLE IF ONE OF THE FOLLOWING HAS

OCCURRED:

A) BASE COURSE GRAVELS HAVE BEEN INSTALLED IN AREAS TO BE PAMED;
B) AN KINAMUM OF 85% VACETATED GROWTH HAS BEEN ESTABLISHED;
C) AN MINIMUM OF 30° OR MONE-ROSINE MATERIALS, SOLVE AS STONE OR
KIJFRAP HAS BEEN INSTALLED; OR
D) EROSION CONTROL ELAWERS HAVE BEEN PROPERLY INSTALLED.

- INSPECT ALL EROSION CONTROL MEASURES ON A DAILY BASIS AND AFTER EVERY 0.5 INCHES OF PRECIPITATION. MAINTAIN SEDIMENT FENCE, SEDIMENT TRAPS, HAY BALES, ETC., AS NECESSARY.
- 13. PLACE TOPSOIL, SEED AND MULCH.
- 14. COMPLETE ALL REMAINING PERMANENT EROSION CONTROL STRUCTURES.
- MONITOR THE SITE AND MAINTAIN STRUCTURES AS NEEDED UNTIL FULL VEGETATION IS ESTABLISHED.

NH STATE PARKS

horizans

176 Newport Road, Suite 8; New London NH 03255 (603) 877-0116

Engineering

Campground Expansion Project Pl Mollidgewock State Park 1437 Berlin Road Berlin, NH

80% DESIGN

Scale: N/A Date: November 22, 2023


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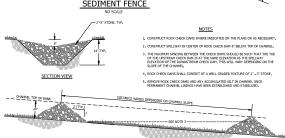


EROSION CONTROL **DETAILS**

C3.00


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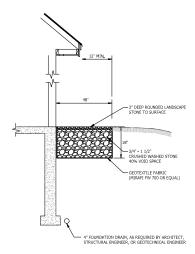
ROCK CHECK DAM DETAIL

NO SCALE

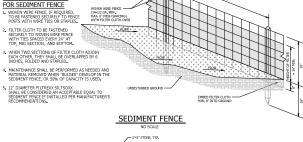


SEDIMENT FENCE POCKET


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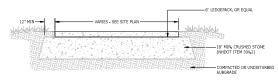
INFILTRATING STONE DRIP EDGE DETAIL

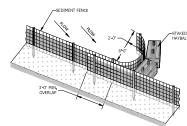

BARRIER ROCK DETAIL

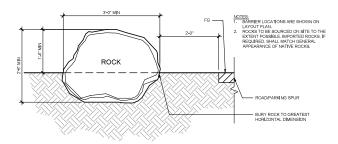

TYPICAL LEDGE PACK WALKWAY SECTION

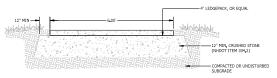

TYPICAL LEDGE PACK PARKING AREA SECTION DETAIL

176 Newport Road, Suite 8; New London NH 03255 (603) 877-0116 www.horizonsengineering.com

NH STATE PARKS

Campground Expansion Project PII Mollidgewock State Park 1437 Berlin Road Berlin, NH 03579

80% DESIGN

Scale: N/A Date: November 22, 2023

Drawn By: DW


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CIVIL DETAILS

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PROGRESS PRINT NOT FOR CONSTRUCTION

Project Number: 23045001 File: 220838 - x-site.dwg



HIGH WATER ALARM: 1,219.53

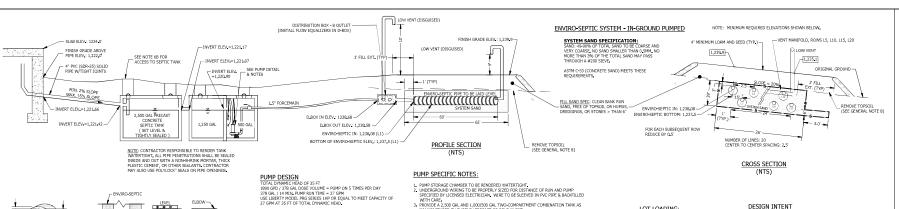PUMP ON: 1,219.28

TANK BOTTOM: 1,216-25

PUMP DETAIL

(NTS)

PUMP OFF: 1,216.58

GENERAL NOTES

 THE CONTRACTOR SHALL ADHERE STRICTLY TO THESE PLANS AND THE REGULATIONS SET FORTH IN THE NEW HAMPSHIRE DEPARTMENT OF ENVIRONMENTAL SERVICES MANUAL "SUBDIVISION AND INDIVIDUAL SEWINGE DISPOSAL SYSTEM DESIGN RULES". CHAPTER ENV-WO 1000, DATED OCTOBER 1, 2016, CURRENT EDITION, AS WELL AS "THE PRESBY WASTEWATER TREATMENT SYSTEM, NEW HAMPSHIRE DESIGN AND INSTALLATION MANUAL", CURRENT

-ELBOW AS NEEDED

TOP VIEW

ENVIRO-SEPTIC OFFSET ADAPTOR DETAIL

SIDE VIEW

END VIEW

TREE NOTE:
ALL TREES WITHIN 10 FEET OF
PROPOSED EDA TO BE REMOVED
AND DISPOSED OF OFF SITE BY
THE INSTALLER (CONTRACTOR

2 CALL DIG-SAFE PRIOR TO INSTALLATION

END VIEW

- 3. SEPTIC SYSTEM SHALL BE INSTALLED BY A NHDES LICENSED INSTALLER.
- 4. TOPOGRAPHY AND SURVEY INFORMATION PROVIDED BY HORIZONS ENGINEERING, INC, OF LITTLETON, NEW HAMPSHIRE. THIS PLAN IS NOT MEANT TO REPRESENT A PROPERTY BOUNDARY
- ENVIRO-SEPTIC LEACHING SYSTEM AS MANUFACTURED BY INFILTRATOR WATER TECHNOLOGIES / PRESBY ENVIRONMENTAL, INC., WHITEFIELD, NH.

- 6. COMES ONES RECORDS STITLE!
 A. SER MINIORM ONCE SHALL SE RECORDS OVER THE PIPE FROM THE BUILDING TO THE SETTIC TANK OR THE PIPE SHALL SE INSULATED.
 I IF THE FRIEND GAUGE COMES THE SECURIT TANK IS GENERAL TANK 14" PROVIDE 30" HOPE COMES FOR HAINTENANCE, SIZES AND COMES SHALL DETERO TO STRIKEND GRADE.
 CENTER OF THE STRIKEND STATES OF THE STRIKEND TO TRISHING GRADE.
 FERLIUED ISSORD, ALEEK MINIOR OVERT TO BE 6" WITH APPEARS COMES BERG 12". THE
- FINISH GRADE IS TO BE SLOPED TO DRAIN OF THE TOP OF THE SYSTEM AT MINIMUM OF THE

 MAINTAIN Z OF COVER ONER THE PIPE FROM THE SEPTIC TANK TO THE ENVIRONMENT


 OR THE PIPE SHALL BE INSULATED. 7. IF THE CONTRACTOR DETERMINES THAT EXISTING FIELD CONDITIONS ARE OTHER THAN SHOWN
- ON THESE PLANS, HE SHALL STOP WORK IMMEDIATELY AND NOTIFY THE OWNER AND DESIGNER FOR DIRECTIONS. IT CONTRACTOR INCOUNTERS EXISTING SEPTIC TANK OR METALLATIONS. THE WITH RESPONSIVE TO CURRENT LOCAL AND STATE REGULATIONS. B. ALL TREES, ROOTS, LOAM AND OTHER ORGANIC MATTER SHALL BE REMOVED FROM LINDER LEACHFIELD AND SLOPE EXTENSIONS PRIOR TO PLACING FILL PLACE FILL IN 16" LIFTS, CONSOLIDATE AND RAKE BACKFILL SCARIFY SUBGRADE SOIL.
- FILL USED TO RAISE THE EFFLUENT DISPOSAL AREA SHALL BE CLEAN BANK RUN SAND, FREE FROM TOPSOIL, HUMUS, DREDGINGS, OR STONES OR MATERIAL MORE THAN 6" IN DIAMETER.
- 10. ALL DISTURBED AREA SHALL BE LOAMED, SEEDED, FERTILIZED AND MULCHED.

- 11. RECOMMENDED OPERATING PROCEDURES:
 A PUMP SEPTIC TANKS ONCE EVERY TWO YEARS.
 B. USE BIODEGRADABLE DETERGENTS.
 C. PAIRER PRODUCTS ONLY TO BE FLUSHED. FLUSHABLE BATHROOM PRODUCTS CAN CLOG THE
- PAPER PROJUCTS ONLY TO A STATE OF THE PAPER PROJUCTS ONLY TO A STATE SAVING DEVICES AND PROCEDURES ARE RECOMMENDED.

 D. WATER SAVING DEVICES AND PROCEDURES ARE RECOMMENDED.

 EATH PRUTURE REPLACEMENT SYSTEM, IF NEEDED, SHALL BE LOCATED IN THE SAME LOCATION AS THIS DESIGN UNLESS CONDITIONS AT THE TIME OF REPLACEMENT DICTATE OTHERWISE, AS THIS DESIGN UNLESS CONDITIONS AT THE TIME OF REPLACEMENT DICTATE OTHERWISE.
- F. THE TANK SIZE SHALL BE INCREASED BY 50% IF A GARBAGE GRINDER IS TO BE INSTALLED. 12. PIPES AND CONNECTIONS OUTSIDE OF THE LEACHING AREA SHALL BE WATER TIGHT. THE CONNECTIONS SHALL BE SEALED WITH NON-SHRINK HYDRAULIC CEMENT.
- THE DISTRIBUTION BOX SHALL HAVE S.S.I. INC. FLOW EQUALIZERS INSTALLED IN THE OUTLET PORTS.
- 14. THIS SYSTEM HAS NOT BEEN DESIGNED FOR VEHICULAR TRAFFIC. THEREFORE, THE SYSTEM SHOULD BE PROTECTED FROM ANY WHEEL VEHICLES.
- 15. THE SITE IS LOCATED WITHIN THE NHDES PROTECTIVE SHORELAND.
- 16. THIS SYSTEM HAS NOT BEEN DESIGNED FOR VEHICULAR TRAFFIC. THEREFORE, THE SYSTEM SHOULD BE PROTECTED FROM ANY WHEEL VEHICLES.
- 17. THERE ARE JURISDICTIONAL WETLANDS ON WITHIN 75' OF THE SYSTEM.
- 18. THERE ARE NO KNOWN BURIAL SITES, BURIAL GROUNDS, OR CEMETERIES WITHIN 25' OF THE SYSTEM OR ON THE PROPERTY.



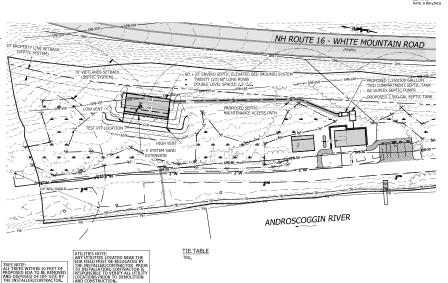

- PROVIDE A 2,500 GAL AND 1,000/500 GAL TWO-COMPARTMENT COMBINATION TANK AS MANIFACTURED BY PEDCENT PRESCRIPT OR EQUILABLY.
 PRINCES BY PROVIDED BY THE STATE OF PROVIDENCE TO SUBPOSE A PURPOSE PROVIDENCE TO STATE OF THE STATE OF
- RGE LINE FROM PUMP CHAMBER TO LEACHFIELD SHALL BE 1.5" HDPE FLEXIBLE PIPE OR EQUIVALENT.

ALLOW ENOUGH CARLE TO DEMOVE DUMP & PIPING WITHOUT DISCONNECTING WIRING IN CONNECTION BOX. OUND - FOREST FLOOR HEMIC ORGANIC NATERIALS, WEAK FINE GRANIII AR. V. FRIMILE INSTALL 3/8" WEEP HOLE TO DRAIN PRESSURE LINE 1.5' DELIVERY LINE INV. OUT ELEV.: 1,221.45 FINE SANDY LOAM, WEAK MEDIUM GRANULAR, V. FRIABLE 10YR 3/1 6* FINE SANDY LOAM, MCCERATE MEDILIN GRANULAR, V. FRIABLE 7.5YR 2.5/2 10° UBMERSIBLE CAST IRON FINE SANDY LOAM, MODERATE MEDIUM GRANULAR, FRIABLE FINE SANDY LOAM, STRONG NED. SUBANG BLOCKY, FRIABLE, CONNON PREDOMINENT SYR3/4 REDOXIMORPHIC CONCENTRATION EFFLUENT PUMPS, 1 HF 10YR 3/4 20" MLC-20 HIGH WATER ALARM CONTROL - MERCURY TYPE SWITCH SEALED IN POLYPROPYLENE FLOAT BALL. 2.5Y 4/3 28" - 4" CONCRETE BLOCK TO KEEP PUMP INLET OUT OF SLUDGE L 2,5Y 4/2 68"

E.S.H.W.T.: 20" WATER OBSERVED: NON RESTRICTIVE LAYER: 28"

SOILS TYPE: 770 MARLOW FINE SANDY LOAM, 15-10% SLOPES, V. STONEY REFERENCE: NRCS WEB SOIL SURVEY, COOS COUNTY, NH

PERCOLATION TEST DEPTH: 16" RATE: 8 MIN (INCH

WAIVER REQUESTS
WAIVER REQUESTED FOR RELIEF FROM BW. WQ, 1008 - REQUIRED 75'

LOCATION MAP

DIRECTIONS: FROM MILAN, NH - NORTH ON NH-16. AFTER 23MJ, RIGHT INTO MOLLIDGEWOCK CAMPGROUND ENTRANCE, APPROX 0.25ML TO SITE ON THE RIGHT.

DESIGN INTENT
BOTTOM OF EFFLUENT DISPOSAL AREA TO BE SET AT ELEV: 1,230,83
THIS IS APPROXIMATELY 10' ABOVE GRADE AT THE LOW CONTOUR OF
THE DESIGNED FETUENT DISPOSAL AREA BENCH MARK AND
ELEVATION DATA TO BE USED TO DETERMINE THE ACTUAL ELEVATION
OF THE FELE POR GREATER ACCURACY. LOT LOADING: MOLLIDGEWOCK STATE PARK IS APPROX, 46.5 ACRES, PROJECT MEETS LOT LOADING.

EFFLUENT DISPOSAL AREA

ZWB STEE SERVED-12

FORDPIT TRAILER STEE SERVED-12

REQUIRED SERVER LOADING-1 89 500

FORDPIT SERVER SERVED-12

REQUIRED SERVER LOADING-1 89 500

FORDPIT SERVER SE

SEPTIC TANK
REQUIRED -2,000 GAL + 70% DAILY FLOW = 3,323 GAL (ENV. WO 1010.02/C PROVIDED - 2,500 GAL & 1,250 GAL TANKS W/ PUMP CHAMBER

BENCHMARKS USED FOR TIE POINTS
TO BE LEFT IN PLACE AND VISIBLE UNTIL THE
NHOES INSPECTION HAS BEEN COMPLETED AND APPROVED.
NO OPEN WATER, WELLS OR ABUITTING FOUNDATIONS
WITHIN 75 OF THE PROPOSED EFFLUENT DISPOSAL AREA.

VENT REQUIREMENTS AND PLACEMENT
WHERE SHOWS, LOW AND HOST WITH AND RECOURDED TO BRUSHER THAT ARE
SHOWN DOWNERS. THROUGH THE PRITTIES STITES IN, NO ADDITIONAL
STATES OF THE PRITTIES STITES AND AND ADDITIONAL
WITH NOAST ROVING AT LIKET THE SAME FLOW CONCETT AS LOW WITHS
CONCECTIONS WITH THE SYSTEM NOAST AND NOAS STREAM CONCETTING
THE OPERAND OF THE HIGH WEST MUST BE AT LEAST 10 PREET ABOVE THE
OPERANG OF THE VIEW WITH.

LOW VENTS ARE INSTALLED THROUGH AN OFFSET ADAPTER AT THE END OF EACH SERIAL SYSTEM OR BED.

VET LICENTING SHOWN ME. MERGHANT, MO. CALL BE RILCOLTD SO
LONG ACTIVET BELLIO LIBEL ON PETINES BACK TO THE EARL WEST
LONG ACTIVET BELLIO LIBEL ON PETINES BACK TO THE EARL WEST
LONG ACTIVET BELLIO LIBEL ON PETINES BACK TO THE SOURCE WEST
LONG BACK TO ANNUA OF THE WEST
LONG THE WEST
LONG BACK THE VEHI COVERS ARE NOT PREFERED. USE THEMHOOM STYLE
WHIT COVERS ARE VEHI COVERS THE ANNUAL MET HE DAY HET.

ENVIRO-SEPTIC SYSTEM SLOPED, IN-GROUND BED

CAMPGROUND DESIGN (1,890 GPD) NEW HAMPSHIRE

> 172 PEMBROKE ROAD CONCORD, NH 03301

PREVIOUS APPROVAL #: NONE

MOLLIDGEWOCK STATE PARI ERROL, NEW HAMPSHIRE TAX MAP: R-6, PARCEL: 14

COUNTY: COOS SUBDIVISION NAME: n/a SUBDIVISION APPROVAL: EXCEPT > 5AC

NH STATE PARKS

horizans

176 Newport Road, Suite 8; New London NH 03255 (603) 877-0116

Campground Expansion Project Pl Mollidgewock State Park 1437 Berlin Road Berlin, NH 03579

80% DESIGN

scale: N/A

Date: November 22, 2023

Drawn By: DW


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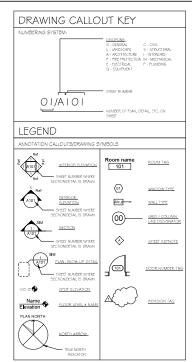
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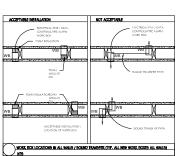
SEPTIC PLAN


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Project Number: 23045001 File: 220838 - x-site.dwg







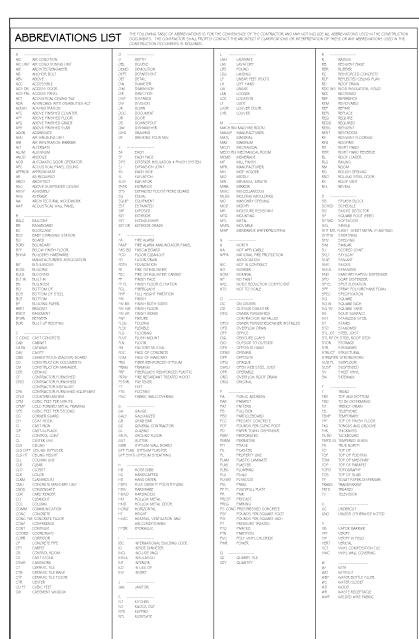

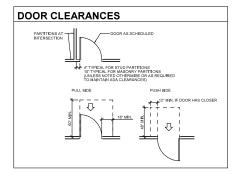SAMYN - D'ELIA ARCHITECTS, P.A

P.O. Box 229 Holderness, NH 03245 tel: (603) 968-7133

> FOR REVIEW NOV. 29, 2023 NOT FOR CONSTRUCTION

HVAC, Elec. & Plumb, Engineer: Charles P. Buckley, P.E. 500 Depot Street Rumney, NH 03266 tel: (603) 786-9992

Structural Engineer Fisher Engineering, P.C. 686 Belknap Mountain Road Gilford, NH 03249 tel: (603) 528-7641

NH STATE PARKS

Campground Expansion Project PII Mollidgewock State Park 1437 Berlin Road Errol, NH 03579

Leerse

80% DESIGN

Scale: As indicated Date: Nov. 29, 2023

Drawn By: MR

Checked By: WD

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GENERAL NOTES. ABBREVIATIONS ANNOTATIONS LEGENDS, & WALL TYPES

A0.01

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FIRE RESISTANCE RATINGS REQUIREMENTS:


~ BUILDING ELEMENTS (TABLE 601) BUNDING ELEMENTS TRAVE 601)

- PRIMARY STRUCTURAL PRAVIS: 0 HR
- EXTERIOR BEARING WALLS: 0 HR
- INTERIOR BEARING WALLS: 0 HR
- EXTERIOR NON-BEARING WALLS: 0 HR
- INTERIOR NON-BEARING WALLS: 0 HR
- FLOOR CONSTRUCTION: 0 HR
- ROOF CONSTRUCTION: 0 HR

- MAXIMUM TRAVEL DISTANCE: 200 FEET (38.2.6.3)
- MAXIMUM DEAD-FIND CORRIDOR LENGTH: 20 FEET (38.2.5.2)
- MAXIMUM COMMON PART OF TRAVEL: 75 FEET (38.2.5.3.1)
- MITERIOR FRISH, WALLS AND CELING: A, B, or C (38.3.3)
- INTERIOR FRISH, WALLS AND CELING: A, B, or C (38.3.3)

ENERGY CODE - MINIMUM THERMAL ENVELOPE REQUIREMENTS:

CODE SUMMARY

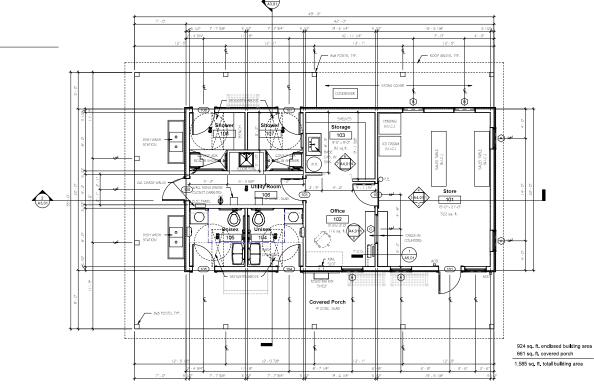

SAMYN - D'ELIA ARCHITECTS, P.A

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NH STATE PARKS

Campground Expansion Project PII Mollidgewock State Park 1437 Berlin Road Errol, NH 03579

80% DESIGN

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Scale: As indicated

Date: Nov. 29, 2023

Drawn By: MR Checked By: WD


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MAIN FLOOR PLAN


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MAIN FLOOR PLAN



MAIN LEVEL REFLECTED CEILING PLAN
Scale: 1/4" = 1-0"

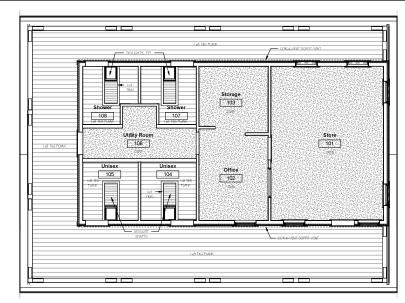

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NH STATE PARKS

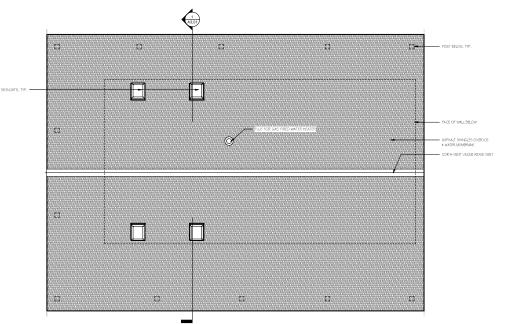Campground Expansion Project PII Mollidgewock State Park 1437 Berlin Road Errol, NH 03579

Issue

80% DESIGN

Graphic Scale

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Scale: 1/4" = 1'-0"

Date: Nov. 29, 2023

Drawn By: MR

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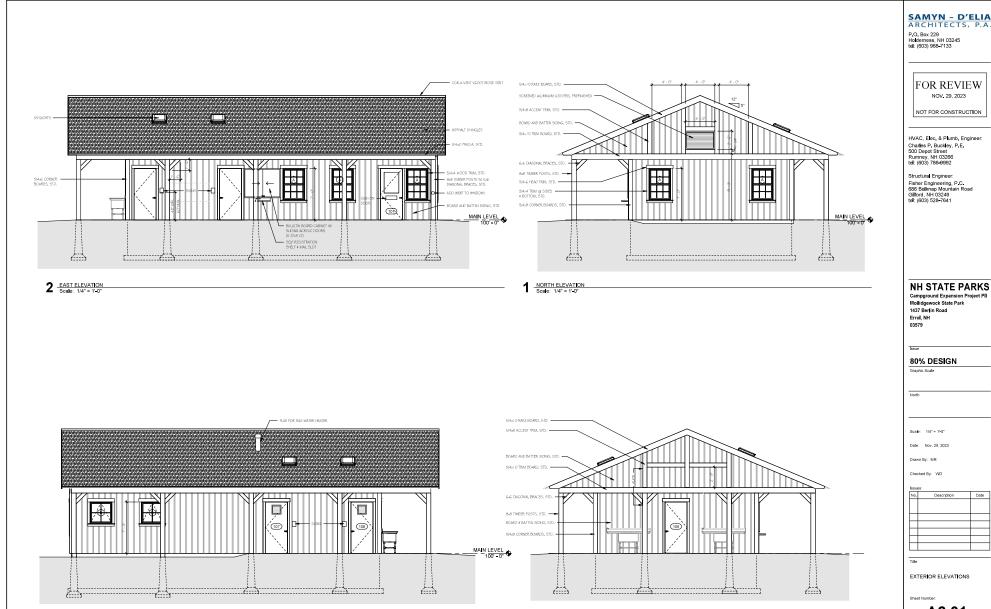
MAIN FLOOR REFLECTED CEILING & ROOF PLAN

Sheet Number:

A1.02

ject Number: 2136A

ROOF PLAN
Scale: 1/4" = 1'-0"



3 SOUTH ELEVATION
Scale: 1/4" = 1'-0"

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FOR REVIEW


HVAC, Elec. & Plumb, Engineer:

Campground Expansion Proj Mollidgewock State Park 1437 Berlin Road Errol, NH

No.	Description	Date
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A2.01

4 WEST ELEVATION
Scale: 1/4" = 1'-0"

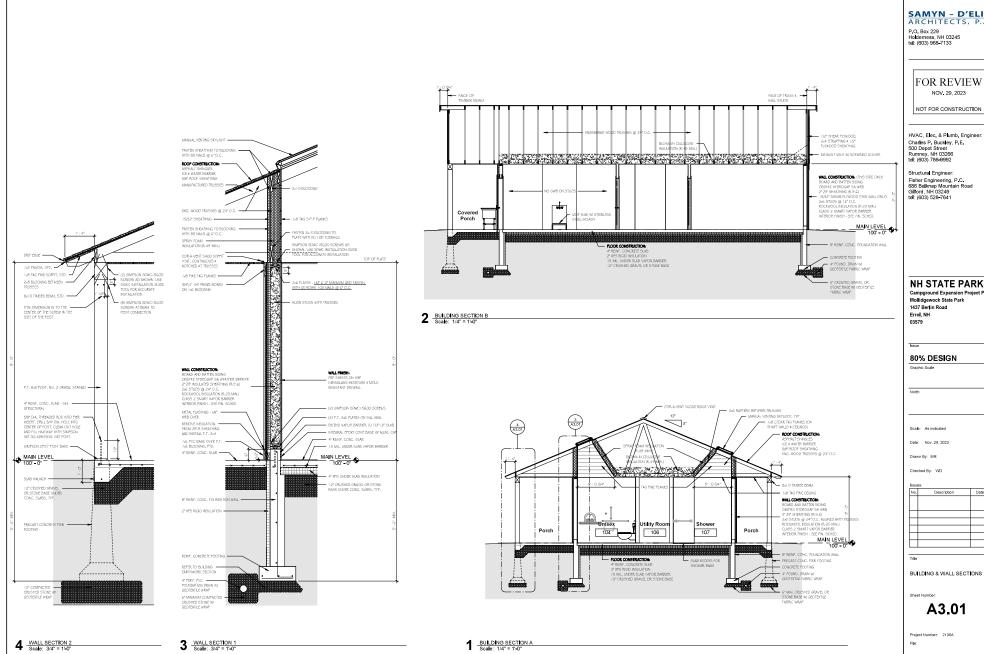

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NH STATE PARKS

Campground Expansion Project PII Mollidgewock State Park 1437 Berlin Road Errol, NH 03579

80% DESIGN

Scale: As indicated

Date: Nov. 29, 2023


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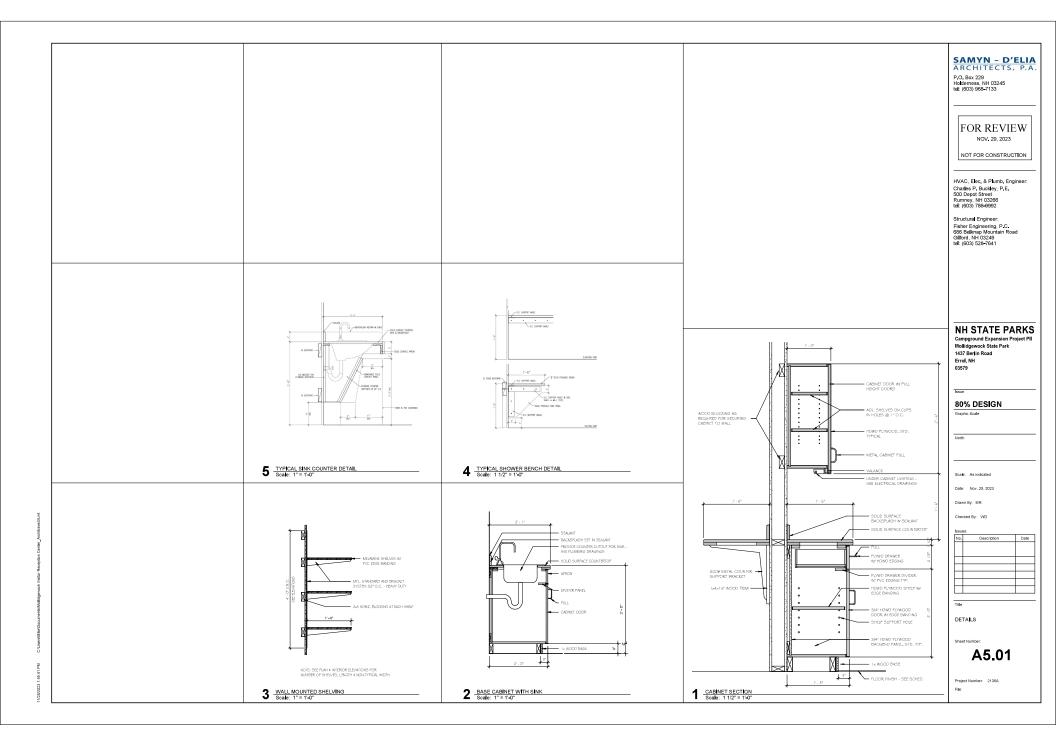
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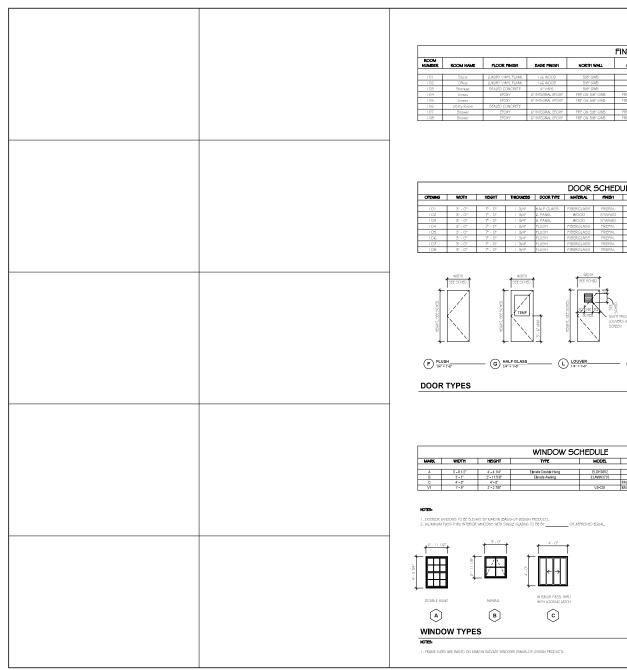
BUILDING & WALL SECTIONS

Sheet Number

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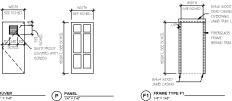




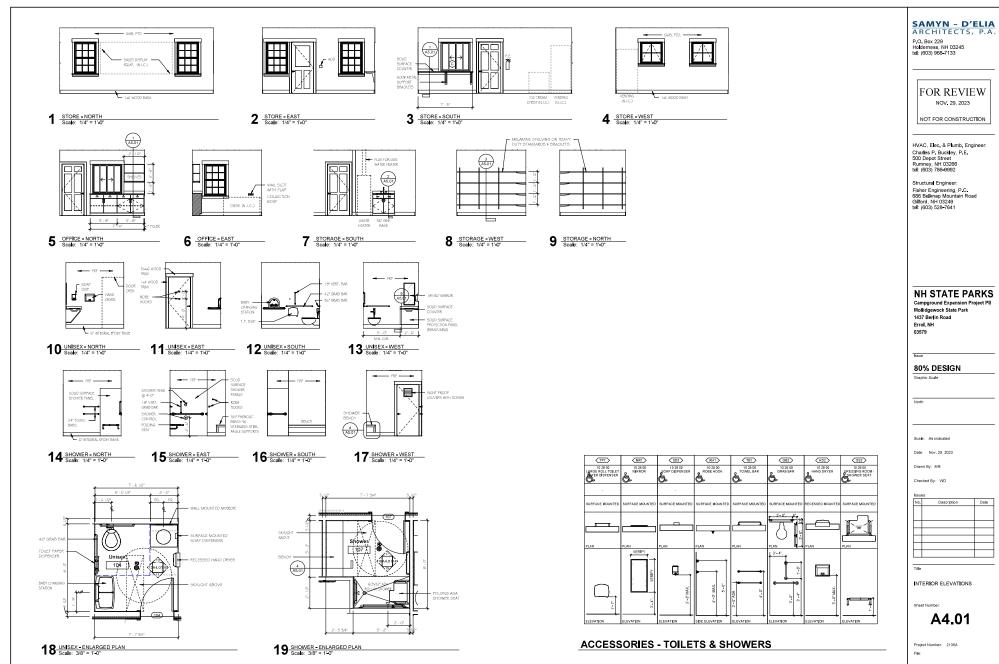

FINISH SCHEDULE EAST WALL SOUTH WALL WEST WALL CEILING FINISH сомментя

DOOR SCHEDULE											
OPENING	WIDTH	HEIGHT	THICKNESS	DOOR TYPE	MATERIAL	MISH	PRAME MATERIAL	FRAME FINISH	COMMENTS		
101	3' - 0"	7-0"	1.3/4"	HALF GLASS	PIBERGLASS	PREPIN.	FIBERGLASS	PREMN.			
102	3' - 0'	7'-0"	1.3/4*	G PANEL	WOOD.	STAINED	WOOD	STAIN			
103	3'-0"	7'-0'	1.3/41	6 PANEL	WOOD	STAINED	WOOD	STAIN			
104	3' - 0"	7-0	1.3/4*	flush .	FIBERGLASS	PREMIN.	FIBERGLASS	PREMN.			
105	3' - 0"	7 - 0"	1.3/4*	fLUSH	FIBERGLASS	PREFIN.	ABERGLASS	PREFIN.			
106	3' - 0'	7'-0"	1.3/4*	FLUSH	FIBERGLASS	PREFIN.	FIBERGLASS	PREFIN.			
107	3' - 0"	7-0	1.3/4"	PLUSH	PIBERGLASS	PREPIN.	PIBERGLASS	PREPIN.	12'x12" LOUVERS WITH SCREENS		
108	91 (01	70 01	1.8741	FLUSH	FIREPGIAGE	PREEM	RREPGLASS	PREEN	12/UT2/TOTIVERS WITH SCREENS		



FRAME TYPES

	WINDOW SCHEDULE											
MARK	WIDTH	HEIGHT	TYPE	MODEL	COMMENTS	COUNT						
A	3'-0 1/2"	4"-4 1/4"	Elevate Double Hung	ELDH3652		- 5						
В	3'-1"	2"-11 5/8"	Elevate Awring	ELAWN3735		2						
С	4'-0"	4'-0"			PASS-THROUGH WITH SINGLE GLASS	1						
V1	1'-9"	2'= 2 7/8"		VS-001	BASIS-OF-DESIGN: VELUX VS-C01	4						

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NH STATE PARKS

Campground Expansion Project PII Mollidgewock State Park 1437 Berlin Road Errol, NH 03579

80% DESIGN

Scale: 1/4" = 1'-0"

Date: Nov. 29, 2023

Drawn By: MR


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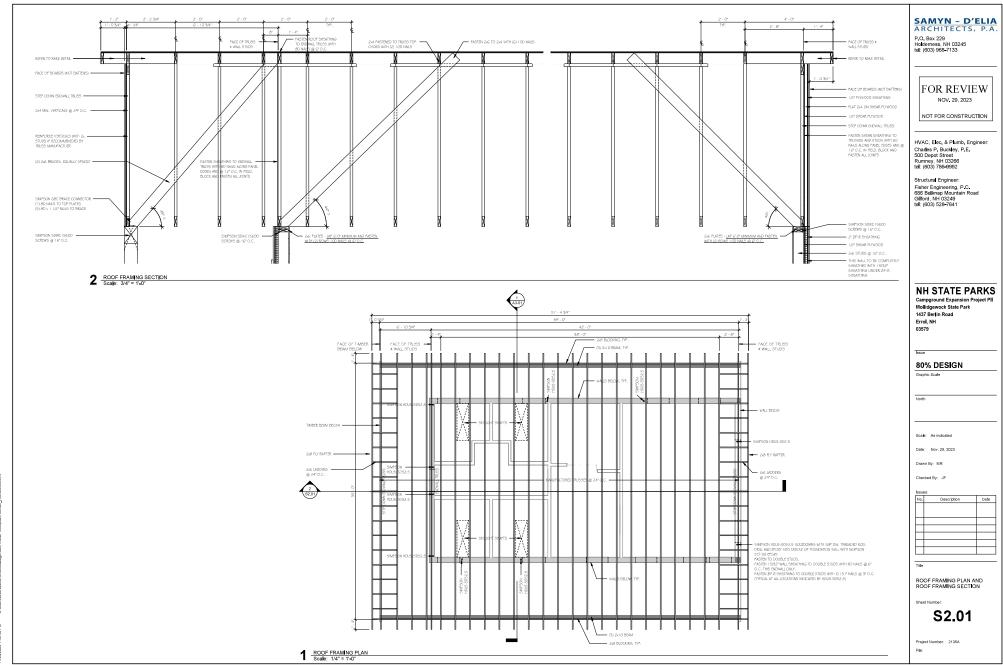
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SCHEDULES


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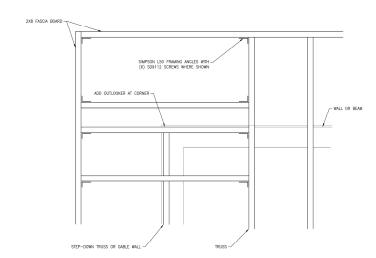


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TYPICAL DOOR/WINDOW OPENING/HEADER DETAILS


4 RAKE DETAIL
Scale: 1/4" = 1'-0"


2 TYPICAL DOOR/WINDOW OPENING/HEADER DETAILS Scale: N.T.S.

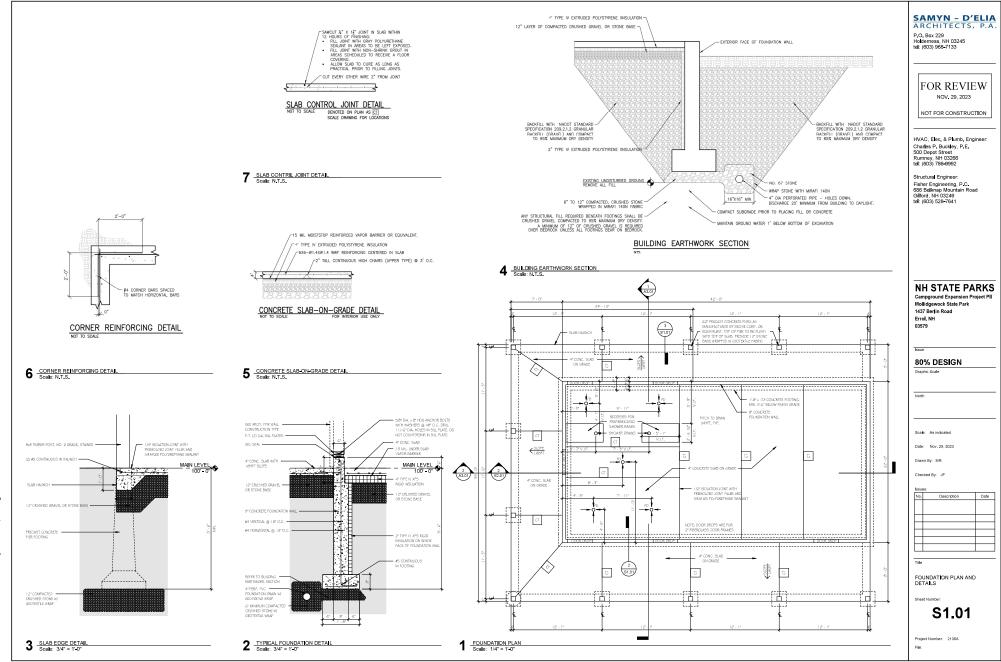


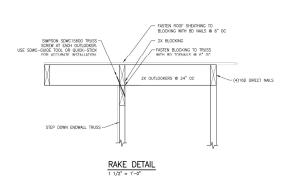TYPICAL DETAIL AT ROOF CORNERS

3 TYPICAL DETAILS AT ROOF CORNERS
Scale: 1/4" = 1'-0"

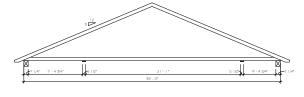

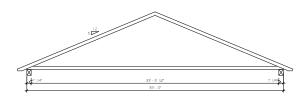

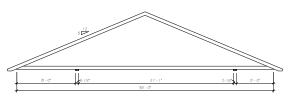

NOTE; TRUSSES ARE TO BE DESIGNED FOR THE WORST CASE OF THE THREE BEARING CONDITIONS SHOWN. SUBMITTRUSS DESIGNS FOR EACH OF THE THREE BEARING CONDITIONS.

TRUSS DIAGRAMS
Scale: 1/4" = 1'-0"

SAMYN - D'ELIA ARCHITECTS, P.A.

P.O. Box 229 Holderness, NH 03245 tel: (603) 968-7133

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Structural Engineer: Fisher Engineering, P.C. 686 Belknap Mountain Road Gilford, NH 03249 tel: (603) 528-7641

NH STATE PARKS

Campground Expansion Project PII Mollidgewock State Park 1437 Berlin Road Errol, NH 03579

80% DESIGN

Graphic Scale

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Scale: 1/4" = 1'-0"

Date: Nov. 29, 2023

Drawn By: MR

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TRUSS DIAGRAMS AND DETAILS

Sheet Number:

S3.01

oject Number: 2136A

HVAC NOTES

1. SCOPE OF WORK

- A. THE CONTRACTOR IS RESPONSIBLE FOR ALL WORK, MATERIALS, AND LABOR TO SATISFY A COMPLETE WORKING SYSTEM WHETHER SPECIFIED OR IMPLIED.
- B. ALL WORK IS TO BE PERFORMED IN STRICT COMPLIANCE WITH THE INTERNATIONAL MECHANICAL CODE 2018, ALL LOCAL AND ALL OTHER REGULATION GOVERNING WORK OF THIS NATURE
- C. THE CONTRACTOR SHALL, BEFORE SUBMITTING ANY PROPOSAL, EXAMINE THE PROPOSED SITE AND SHALL DETERMINE FOR HIMSELF THE CONDITIONS THAT MAY EFFECT THE WORK, NO ALLOWANCE SHALL BE MADE IF THE CONTRACTOR FAILS TO MAKE SUCH EXAMINATIONS.
- D. ALL EQUIPMENT AND MATERIALS SHALL BE AS SPECIFIED OR "APPROVED EQUAL" BY THE ENGINEER OR ARCHITECT.

2. PERMITS

A. THE CONTRACTOR SHALL SECURE ALL PERMITS OR APPLICA-TIONS AND PAY ANY AND ALL FEES.

3. SHOP DRAWINGS

A. SUBMIT MATERIAL LIST AND SHOP DRAWINGS FOR MAJOR EQUIPMENT TO THE ACHITECT/ENGINEER FOR APPROVAL. THE CONTRACTOR SHALL SUBMIT FIVE SETS OF SHOP DRAWINGS AND THEY SHALL BE CLEARLY LABELED.

DUCTWOR

- A. THE DUCTWORK SHALL BE CONSTRUCTED IN ACCORDANCE WITH THE "SMACNA" APPLICABLE MANUALS. ALL DUCTWORK SHALL BE THE LOW VELOCITY TYPE, UNLESS SPECIFIED OTHERWISE.
- B. CONTRACTOR SHALL PROVIDE AND INSTALL APPROVED FIRE DAMPERS AND ACCESS PANELS IN ANY AND ALL DUCTWORK WHICH PENETRATES A HORIZONTAL OR VERTICAL FIRE PARTI-TION, OR AS OTHERWISE SHOWN ON DRAWINGS.
- C. ALL BRANCH DUCTS TO HAVE VOLUME DAMPERS.
- D. SMOOTH TURN RADIUS DUCTWORK OR TURNING VANES SHALL BE USED THROUGHOUT WHERE FLOW EXCEEDS 150 CFM.
- E. ALL DUCT JOINTS TO BE SEALED IN ACCORDANCE WITH "SMACNA" STANDARDS AND ACCEPTED GOOD PRACTICE.
- F. ALL DUCT DIMENSIONS SHOWN ARE NET INSIDE VALUES.
 DIMENSIONS MAY BE CHANGED SO LONG AS THE NET FREE
 FACE AREA IS MAINTAINED.

HVAC CONTROLS

A, CONTRACTOR TO SUPPLY AND INSTALL ALL CONTROL WIRING AND THERMOSTATS AS REQUIRED.

6. ELECTRICAL

A. CONTRACTOR TO COORDINATE WITH ELECTRICAL CONTRACTOR FOR LOCATION OF WIRING FOR EACH HVAC UNIT.

7. MISCELLANEOUS

- A. ALL EXTERIOR OPENINGS TO BE PROPERLY CAULKED AND SEALED WITH A SEALANT OF HIGH QUALITY AND LONG LIFE, TO PREVENT INFILTRATION OF OUTSIDE AIR INTO CONDITIONED SPACE.
- B. DO NOT SCALE THIS DRAWING FOR EXACT DIMENSIONS. VERIFY ALL FIGURES, CONDITIONS, AND DIMENSIONS AT THE JOB SITE.
- C. THE MECHANICAL PLANS ARE INTENDED TO BE DIAGRAM-MATID AND ARE BASED ON DIE MAUHRACHER'S EQUIP-MENT. THEY ARE NOT INTENDED TO SHOW EVERY ITEM IN TIS EXACT LOCATION, THE EXACT DIMENSIONS, OR ALL THE DETAILS OF THE EQUIPMENT. THE CONTRACTOR SHALL VEREY THE ACTUAL DIMENSIONS OF THE FOUR-MENT PROPOSED TO DISURE THAT THE EQUIPMENT WILL FIT IN THE AVAILABLE SPACE.


8. TESTING AND BALANCING

A. THE HVAC SYSTEM SHALL BE TESTED AND AND BALANC— ED BY AN INDEPENDENT AGENCY, UNDER THE SUPERA-VISION OF A LICENSED PROFESSIONAL BENGIEER. A SEALED TYPE WRITTEN REPORT SHALL BE SUBMITTED TO THE ARCHITECT/SENDIERE FOR REWEW AND APPROVAL.

9. GUARANTEE

Coulk All Around -

- A. MATERIALS, EQUIPMENT AND INSTALLATION SHALL BE GUARANTEED FOR A PERIOD OF CNE(1) YEAR FROM DATE OF ACCEPTANCE. DEFECTS WHICH APPEAR DURING THAT PERIOD SHALL BE CORRECTED AT THIS CONTRACTOR'S EXPENSE.
- B. FOR THE SAME PERIOD, THE MECHANICAL CONTRACTOR SHALL BE RESPONSIBLE FOR ANY DAMAGE TO PREMISES CAUSED BY DEFECTS IN WORKMANSHIP OR IN THE WORK OR EQUIPMENT FURNISHED AND/OR INSTALLED BY HIM.

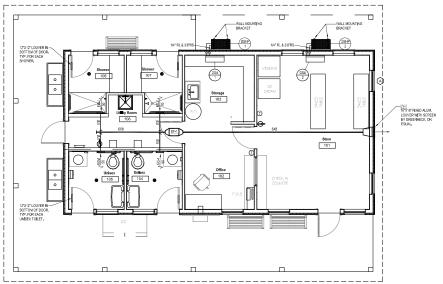

Charles P. Buckley, P.E. 500 Depot Street Rumney, NH 03266 tel: (603) 786-9992 Structural Engineer:

HVAC, Elec. & Plumb, Engineer:

CHARLES P. BUCKLEY

NUMNEY, N.H. 03266 TEL(803)786-9892 FAX.(803)786-2385

N.H. LIC. NO. 09198

OF NEW HAMPS

CHARLES P. BUCKLEY NO. 09198

ONAL COM

Structural Engineer: Fisher Engineering, P.C. 686 Belknap Mountain Road Gilford, NH 03249 tel: (603) 528-7641

NH STATE PARKS

Campground Expansion Project Pil Mollidgewock State Park 1437 Berlin Road Errol, NH 03579

DSA Issue

80% DESIGN

Graphic Scale

North

Scale: As indicated

Date: NOV. 22, 2023

Drawn By: CPB

Checked By: CPB

No.	Description	Date

Title

MECHANICAL PLAN AND DETAILS


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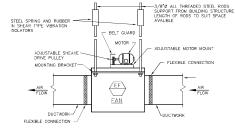
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Project Number: 23045001 File:

	GRILLE - REGISTER - DIFFUSER SCHEDULE										
SR-SUPPLY REGISTER RG-RETURN GRILLE CD-CEILING DIFFUSER EG-EXHAUST GRILLE TG-TRANSFER GRILLE											
EQUIPMENT NO.	SIZE	TYPE	MANUFACTURER & MODEL	FINISH		OPTIONS-ACCESSORIES					
EG-1	8"X8"	EXHAUST GRILLE	HART & COOLEY MODEL RH45 - 8"X8"	WHITE							

	FAN SCHEDULE									
WARK	SERVICE	LOCATION	CFM	STATIC PRESS.	MOTOR			MANUFACTURE & MODEL		
				(IN. W.G.)	HP	RPM	VOLT-PHASE			
EF-1	TOILETS RM.—SHOWERS	CHASE	200	0.625	1/6	1800	115-1	OREENHECK SQ-70-VG		



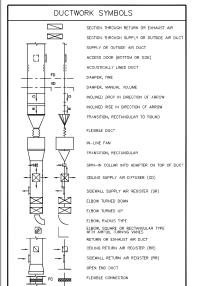

CENTRIFUGAL IN-LINE FAN DETAIL

Storm-Proof Louver To United House Court H

LOUVER CONNECTION DETAIL

NOT TO SCALE

ELECTRICAL NOTES

- 1. SCOPE OF WORK:
- A. CONTRACTOR SHALL WSIT SITE PRIOR TO BIDDING. BIDS SHALL SERVE AS EVIDENCE OF KNOWLEDGE OF EXISTING CONDITIONS. FIELD VERIFY ALL ELECTRICAL EQUIPMENT.
- B. FURNISH ALL LABOR, MATERIALS, EQUIPMENT AND TOOLS TO PERFORM ELECTRICAL WORK SHOWN, NOTED OR SCHEDULED FOR A COMPLETE AND FINISHED INSTALLATION.
- MATERIALS, PRODUCTS AND EQUIPMENT, INCLUDING ALL COMPONENTS THEREOF, SHALL BE NEW AND SUCH AS APPEAR ON THE UNDERWRITERS LABORATORIES UST OF APPROVED TIES AND SHALL BE SIZED IN CORPORMITY WITH REQUIRELENTS OF THE NATIONAL ELECTRICAL CODE AND OTHER APPLICABLE CODES, WHICHEVER ARE MORE STRINGENT.
- C. ALL WORK TO BE IN ACCORDANCE WITH 2020 NEC AND ALL APPLICABLE FEDERAL, STATE LOCAL CODES.

2. PERMITS:

- A. SECURE AND PAY FOR ALL REQUIRED PERMITS AND INSPECTION CERTIFICATES.
- 3. SHOP DRAWINGS:
- A SUBMIT MATERIAL LIST AND SHOP DRAWINGS FOR MAJOR EQUIPMENT TO THE ARCHITECT FOR APPROVAL. SUBMITTALS SHALL BE IN ACCORDANCE WITH CENERAL CONDITIONS AND SHALL BEAR STAMP OF THE GENERAL CONTRACTOR SHOWNIN THAT HE HAS REVERED AND APPROVED THEM. LACK OF SUCH CONTRACTOR'S APPROVAL WILL BE CAUSE FOR RECEITOR WITHOUT REVEW BY THE ARCHITECT OR FORMSEE.
- 4. CONDUITS:
- A. THE TYPE OF CONDUIT SHALL BE AS FOLLOWS FOR ALL FEEDERS AND DISTRIBUTION CIRCUITS, UNLESS OTHERWISE SPECIFIED.

APPLICATION TYPE OF CONDUIT
GALV. RIGID STEEL OR EMT W/ W.P. FITTINGS
EMT
MC
EMT
PVC - SCHEDULE 40 OUTDOORS
BRANCH CIRCUITS (EXPOSED)
BRANCH CIRCUITS (CONCEALED)
SUPPLY TO DISTRIBUTION PANEL
UNDERGROUND SERVICE ENTRANCE

5. <u>WIRE:</u>

- A. WIRE SHALL BE SINGLE CONDUCTOR COPPER WITH 600 VOLT INSULATION. MINIMUM WRI SHALL BE #12 EXCEPT #14 MAY BE USED FOR CONTROL. ALL WIRE AND CABLE SHALL BE NEW AND SHALL BE BROUGHT TO THE SITE IN UNBROKEN PACKAGES.
- . GENERAL WRING SHALL BE THW OR THHN (ALUMINUM CONDUCTORS ARE NOT PERMITTED).
- B. WIRE CONNECTORS SHALL BE EQUAL BY SCOTCHLOCK FOR #6 AND SMALLER AND T & B "LOCK-LITE" FOR #6 AND LARGER.

6. LIGHTING:

- A. LIGHTING FIXTURES AND LAMPS (UNLESS NOTED OTHERWISE) SHALL BE FURNISHED BY THE ELECTRICAL CONTRACTOR. ELECTRICAL CONTRACTOR SHALL INSTALL ALL FIXTURES AND LAMPS.
- 7. WIRE DEVICES:
- A. RECEPTACLES SHALL BE 20 AMP, 3-WIRE GROUNDING TYPE EQUAL TO HUBBELL 5362 (MOUNTING @ 18 A.F.F.).
- B. SWITCHES SHALL BE STANDARD GRADE RATED 20 AMP AT 120 VOLT (MOUNTING 048 A.F.F.)

8. SAFETY SWITCHES:

- A. PROWDE SAFETY AND DISCONNECT SWITCHES, FUSED OR NONFUSED, AS CALLED FOR ON BRAWMIGS AND AS REQUIRED BY CODE. SWITCHES SHALL BE HEAVY DUTY, LOAD AND HORSEPOWER NATIO AS MANUFACTURED BY SQUARE D. GOLUD. ITE OR EQUAL.
- A. OUTLET BOXES AND COVERS SHALL BE GALVANIZED, ONE—PIECE PRESSED STEEL KNOCKOUT.
- B. JUNCTION, PULL BOXES AND COVERS SHALL BE GALVANIZED STEEL, CODE GAUGE SIZE.

10. INSTALLATION:

- INSTALLATION.

 ALL ELECTRICAL WORK SHALL SE INSTALLED SO AS TO BE READLY ACCESSREE FOR OXFORD THE PROPERTY OF THE PROPERTY OF THE PROPERTY OF THE PROPERTY OF THE ALL WEST, AND AS TO ANNELS, ROUSE, ETC., NECESSARY FOR THE ASSTALLATION OF WORK AND BALL SE FASTERED TO STEEL CONCRETE OR WOOD, BUT NOT TO PHYNO. ALL COMDUT SHALL SE CONCRETED TO STEEL CONCRETE OR WOOD, BUT NOT TO PHYNO. ALL COMDUT SHALL SE CONCRETED TO STEEL CONCRETE OR WOOD, BUT NOT TO PHYNO. ALL COMDUT SHALL SE CONCRETED THE PROPERTY OF THE PR
- THE CONTRACTOR HALL DO ALL CUTING, CHASING OR CHANNELING AND PATCHING REQUIRED FOR ANY WORK UNDER THIS DIVISION, SEEVES SHALL EXTEND AT LEAST YOU (27) NICHES ABOVE PRISHED FORM AND LEEVES, OPPOSINGE, ETC., THROUGH FIRE RATED WALLS AND FLORES SHALL BE SEALED AFTER CONDUIT INSTALLATION TO REMAIN THEIR TIME RATING.
- C. THE FOLLOWING EQUIPMENT SHALL BE IDENTIFIED WITH ENGRAYED BAKELITE NAMEPLATES AS TO NAME AND/OR FUNCTION; DISTRIBUTION PANELS AND DISCONNECT SWITCHES.
- D. THE LOCATION OF OUTLETS AND EQUIPMENT SHOWN ON THE DRAWINGS ARE APPROXIMATE AND THE ARCHITECT SHALL HAVE THE RIGHT TO RELOCATE ANY OUTLETS OR FIXTURES BEFORE THEY ARE INSTALLED WITHOUT ADDITIONAL COST.
- E. ELECTRICAL CONTRACTOR SHALL RECORD ALL FIELD CHANGES IN HIS WORK AS THE JOB

11. GUARANTEE:

- A. MATERIALS, EQUIPMENT AND INSTALLATION SHALL BE GUARANTEED FOR A PERIOD OF ONE (1) YEAR FROM DATE OF ACCEPTANCE. DEFECTS WHICH APPEAR DURING THAT PERIOD SHALL BE CORRECTED AT THIS CONTRACTOR'S EXPENSE.
- FOR THE SAME PERIOD, THE ELECTRICAL CONTRACTOR SHALL BE RESPONSIBLE FOR ANY DAMAGE TO PREMISES CAUSED BY DEFECTS IN WORMANSHIP OR IN THE WORK OR COURPMENT FURNISHED AND/OR INSTALLED BY HIM.

12. FINALLY:

A. IT IS THE INTENT THAT THE FOREGOING WORK SHALL BE COMPLETE IN EVERY RESPECT AND THAT ANY MATERIAL OR WORK NOT SPECIFICALLY MENTIONED OR SHOWN ON THE DRAWINGS, BUT NECESSARY TO FULLY COMPLETE THE WORK SHALL BE FURNISHED.

ELECTRICAL SYMBOLS

ABBREVIATIONS

ABOVE COUNTER ABOVE FINISHED FLOOR. EXPLOSION PROOF. GROUND FAULT CIRCUIT INTERRUPTER. GROUND. HORSEPOWER. LICHTING PANEL.
MOTOR CONTROL CENTER.
MOUNTING HEIGHT, MANHOLE.
NATIONAL, ELECTRICAL, CODE.
NATIONAL, ELECTRICAL, MANUFACTURERS ASSOC.
NOT IN CONTRACT. NIGHT LIGHT.
PHOTOELECTRIC SWITCH POWER PANEL. RECEPTACLE PANEL.

UNLESS OTHERWISE NOTED. WIRING



UON WP

WIRING CONCEALED IN CEIUNG OR WALLS; SLASH MARKS INDICATE NUMBER OF CONDUCTORS EXCLUDING GROUNDS; CONDUCTOR SIZE AS MARKED; #12 AWG UON.

UNDERGROUND CABLE OR DUCT; TYPE, SIZE, CONDUCTORS, AND ARRANGEMENT BY NOTATION OR SCHEDULE.

WIRING RUN EXPOSED.

SWITCHES

- S* SWITCH OUTLET: MOUNTED 48" AFF UON: SINGLE POLE UON: LOWER CASE LETTER, WHEN PRESENT, INDICATES OUTLETS
 - ABBREVIATIONS FOR SWITCH OUTLETS
- DOUBLE POLE SWITCH 4-WAY SWITCH
 - KEY OPERATED SWITCH
- DOOR SWITCH
- DIMMER SWITCH; MGUNTED 48" AFF UON; LOWER CASE LETTER, WHEN PRESENT, INDICATES CUTLETS CONTROLLED.

LIGHTING

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RECESSED MOUNTED CEILING FIXTURE SURFACE MOUNTED CEILING FIXTURE

ЮΜ

INCANDESCENT FIXTURE, WALL

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SURFACE OR PENDANT MOUNT EXIT SIGN FIXTURE; ARROWS INDICATE REQUIRED SIGN ARROWS.

BATTERY POWERED EMERGENCY LIGHTING FIXTURE

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COMBINATION EMERGENCY LIGHTING FIXTURE AND EXIT SIGN

RECEPTACLES

- €,, GROUNDED DUPLEX RECEPTACLE (NEWA 5-20R); MOUNTED 18" AFF UON; NUMBER INDICATES CIRCUIT.
- GROUNDED QUADRUPLEX RECEPTACLE (NEMA 5-20R);
- SPECIAL PURPOSE RECEPTACLE; LETTER INDICATES TYPE; TYPE DEFINED BY NOTATION OR SCHEDULE; MOUNTED 18" **⊕** A

PANELS AND MISC.

□ FSS

FUSED SAFETY (DISCONNECT) SWITCH □H_{NFSS} NON-FUSED SAFETY (DISCONNECT) SWITCH

J


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TELEPHONE OUTLET - WALL - MOUNTED 18" AFF, UON PROVIDE 4X4 OUTLET BOX IN WALL WITH 3/4" CONDUIT TO ABOVE CEILING WITH PULL WIRE, WIRING BY OTHERS.

Δ

COMPUTER OUTLET - WALL - MOUNTED 18" AFF UON. PROVIDE 4X4 OUTLET BOX IN WALL WITH 3/4" CONDUIT TO ABOVE CEILING WITH PULL WIRE, WIRING BY OTHERS.



ELECTRICAL POWER PLAN

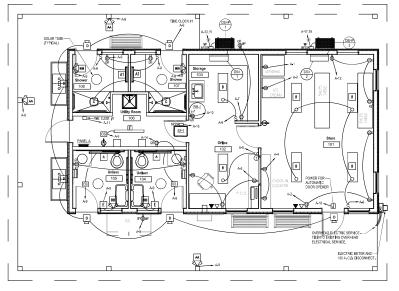ELECTRICAL NOTES

- VERIFY CONDITION AND CAPACITY OF EXISTING FLECTRICAL SERVICE VERIFY CONDITION AND CAPACITY OF EXISTING ELECTRICAL SERVICE
 (MINNAMI TO AND SERVICE). REMOVE THE PERFORME SERVICE
 REQUIRED. PROVIDE THE ULAHITMS, POWER AND CONTROL
 CROLLITING AS REQUIRED
 ALL WORK TO BE PERFORMED IN ACCORDANCE WITH ALL CURRENT
 ELECTRICAL COORS TO BE CONTROLLED BY TIMECLOCK. INTERNATIC
 MOBEL THO! OR APPROVED ECUAL.
- MULLEL FIG. OR APPROVED EQUAL PROVIDE LOW VOLTAGE CELING MOUNTED ULTRASONIC MOTION DETECTOR. GREENCATE MODEL CAC-U-1000-R+SP20-MV OR APPROVED EQUAL

LIGHTIN	LIGHTING FIXTURE SCHEDULE										
MARK	MANUFACTURER	FIXTURE WAKE/MODEL	LAMPING	MOUNTING							
	_										
A	METALUX	4-BCLED-LD4-28SL-F-UNV-L830-CD-1	32W LED	WALL MOUNTED @ 8"-0" AFF							
A1	METALUX	2-BCLED-LD4-16SL-F-UNV-L830-CD-1	18W LED	WALL MOUNTED @ 8'-0" AFF							
В	METALUX	4WSNLED-LD4-40SL-UNV-L840-CD1-U	39W LED	CEILING MOUNTED - SURFACE							
C	HALO	SLD606-8-30-WH	12.5W LED	CEILING MOUNTED							
D	RAB	BRISKS17L-730	14W LED	ABOVE DOOR/BEHIND BEAM/POST							
E	LEGRAND	TM-MLECC	1/4W LED	MOUNT 24" AFF							
F	LITHONIA	CLX L48 4000LM SEF FDL MVOLT G21 80CRI	39W LED	CEILING MOUNTED							
MA.	DUAL-LITE	DYN 6	2-3W LED	MOUNT TOP 6" T.O. WALL							
BB	DUAL-LITE	LZ250I (25 WATT BATTERY)	2-5W/MR16	MOUNT TOP 6" BELOW CEILING							

W	LTS: 120/240	WRE: 3	KA RMS: 1	IO KAIC	NEUTRAL B	AR: YES		BRA	ANCH CE	: BOLT-ON	NEMA TYPE: 1	MFTR: SQUARE "D",	G.E. SIEMENS	OR EQUA
PH	IASE: 1	AMP: 100	MAIN CB	AMP: 100	ROUND BA	R: YES		KEY	LOCK:	YES	MOUNTING: SU	FRACE		
OLT-AN	IPS(V-A) B	CIRCUIT DESC	CRIPTION	CONDUCTOR	POLES	C.B.	CK	Ή#	C.B.	POLES	CONDUCTOR	CIRCUIT DESCRIPTION	VOLT-AN	⊿PS(V− B
1000	\mathbb{N}	RECEPT.		2#12+#12G.	1	20	1		20	1	2#12+#12G.	RECEPT.	1000	\triangleright
> <	1000	RECEPT.		2#12+#12G.	1	20	3	4	20	1	2#12+#12G.	RECEPT.	X	10
1000	X	RECEPT.		2#12+#12G.	1	20	5	-6	20	1	2#12+#12G.	RECEPT	1000	>
=	1000	RECEPT.		2#12+#12G.	1	20	7	8	20	1	2#12+#12G.	RECEPT	\sim	10
600	$^{\vee}$	LIGHTING		2#12+#12G.	- 1	20	9	10	20	1	2#12+#12G.	WATER HEATER RECEPT.	1200	\sim
=	300	TIME CLOCK #1		2#12+#12G.	- 1	20	11	12	20	1	2#12+#12G.	RECEPT.	\times	100
1300	\sim	DSHP-1 - DSA-1		2#12+#12G.	2	15 🕶		14	20	1	2#12+#12G.	RECEPT.	1000	\sim
\sim	1300						15	16	20	1	2#12+#12G.	EF-1	\sim	90
1300	X	DSHP-2 - DSA-2		2#12+#12G.	2	15		18	20	1	2#12+#12G.	J.B AUTO, DOOR OPENER	300	\sim
$\overline{}$	1300						19	20				SPACE	\sim	
	M	SPACE					21	22				SPACE		\sim
=		SPACE					23	24				SPACE	\sim	
	\sim	SPACE					25	26				SPACE		\sim
=		SPACE					27	28				SPACE	S	
	\sim	SPACE					29	30				SPACE		\rightarrow

CUPIE CHARLES P. BUCKLEY

N.H. LIC. NO. 09198



HVAC, Elec. & Plumb, Engineer, Charles P. Buckley, P.E. 500 Denot Street Rumney, NH 03266 tel: (603) 786-9992

Structural Engineer: Fisher Engineering, P.C. 686 Belknan Mountain Road Gilford, NH 03249 tel: (603) 528-7641

NH STATE PARKS

Campground Expansion Project PII Mollidgewock State Park 1437 Berlin Road Errol, NH 03579

80% DESIGN

Graphic Scale

Scale: As indicated Date: NOV. 22, 2023

Drawn By: CPB

Checked By: CPB


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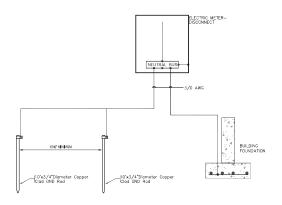
ELECTRICAL PLAN AND DETAILS

E1.01M

Project Number: 23045001



ELECTRICAL RISER DIAGRAM

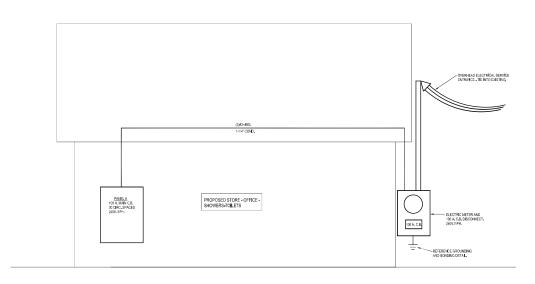

GROUNDING & BONDING DETAIL

NOT TO SCAL



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Issue

80% DESIGN

Graphic Scale

North

Scale: As indicated

Date: NOV. 22, 2023

Drawn By: CPB

Checked By: CPB

No.	Description	Date

Title

ELECTRICAL RISER AND DETAILS

Sheet Number:

E1.02M

Project Number: 23045001

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PLUMBING NOTES 4. SANITARY/STORM DRAINAGE AND VENT PIPING

SCOPE OF WORK

- A. THE CONTRACTOR IS RESPONSIBLE FOR ALL WORK, MATERIALS, AND LABOR TO SATISFY A COMPLETE WORKING SYSTEM WHETHER SPECIFIED OR IMPLIED.
- B. ALL WORK IS TO BE PERFORMED IN STRICT COMPLIANCE WITH THE INTERNATIONAL PLUMBING CCDE (2018).
- C. THE CONTRACTOR SHALL, BEFORE SUBMITTING ANY PROPOSAL, EXAMINE THE PROPOSED SITE AND SHALL DETERMINE FOR HIMSELF THE CONDITIONS THAT MAY EFFECT THE WORK, NO ALLOWANCE SHALL BE WADE IF THE CONTRACTOR FAILS TO MAKE SUCH EXAMINATIONS.
- D. ALL EQUIPMENT AND MATERIALS SHALL BE AS SPECIFIED OR "APPROVED EQUAL" BY ENGINEER OR ARCHITECT.

SHOP DRAWNGS

- A. SUBMIT MATERIAL LIST AND SHOP DRAWINGS FOR MAJOR EQUIPMENT/FIXTURES TO THE ARCHITECT OR ENGINEER FOR APPROVAL. THE SHOP DRAWINGS SHALL BE CLEARLY TAGGED AND HIGHLIGHTED.
- 3. DOMESTIC WATER SUPPLY PIPING
- A. ABOVE GROUND: MAINS AND BRANCHES COPPER PIPE WITH SOLDER JOINTS. BRANCHES PEX WITH PEX FITTINGS.
- B. ALL HOT WATER PIPING TO BE INSULATED WITH 1" FIBERGLASS INSULATION.
- C. ALL COLD WATER PIPING TO BE INSULATED WITH 1/2" FOAM INSULATION.
- D. PROVIDE DOMESTIC WATER SHUT-OFFS AT EACH PLUMBING FIXTURE.
- E. PITCH WATER PIPING TO DRAIN BACK VALVES TO FACILITATE SEASONAL DRAIN DOWN OF ALL WATER LINES.

- -2" AND RELOW: SCH. 40 PVC WITH SOLVENT JOINTS. _T" AND ABOVE SCH. 40 PVC WITH SOLVENT JOINTS. B. BELOW GRADE: SCH. 40 PVC WITH SOLVENT JOINTS.
- C. PVC PIPING SHALL NOT BE USED IN AIR PLENUM CEILINGS AND SHALL NOT CROSS FIRE RATED WALLS, CEILINGS, OR FLOORS.
- D. DRAINAGE PIPING SHALL BE RUN AS STRAIGHT AS POSSIBLE AND SHALL HAVE LONG TURN FITTINGS. E. DRAINAGE PIPING 3" SIZE AND SMALLER SHALL RUN AT A UNFORM GRADE OF AT LEAST 1/4" PER FOOT, AND PIPING LANGER THAIN 3" SHALL BE RUN AT A GRADE OF NO LESS THAIN 1/8" PER FOOT.
- F. CONTRACTOR SHALL BE RESPONSIBLE FOR THE PROPER FLASHING OF THE VENT PIPING RUN THROUGH THE ROOF.
- ALL STUB—INS AND/OR SLAB OR WALL PENETRATION TO BE PER INTERNATIONAL PLUMBING CODE, ALL PIPING PENETRATIONS OF BUILDING FOUNDATIONS, FOOTINGS AND
- 6. PIPE SUPPORTS


A. ABOVE GRADE:

A ABOVE GRADE
ALL PIPE SHALL BE SUPPORTED FROM THE BUILDING
STRUCTURE IN A NEAT AND WORKMANUKE MANNER.
THE USE OF MIRE AND PERFORDED METAL TO SUPPORT
PIPES MILL NOT BE PERMITTED, SPACING OF PIPE SUPPORTS
SHALL BE AS SPECIFIED IN THE INTERNATIONAL
PLUMBING CODE.

- A. COORDINATE INSTALLATION OF ALL ROOF FLASHING AT ROOF PENETRATION.
- B. DO NOT SCALE THIS DRAWING FOR EXACT DIMENSIONS. VERIFY ALL FIGURES, CONDITIONS, AND DIMENSIONS AT THE JOB SITE.
- C. THE PLIMEIRO PLANS ARE INTENDED TO BE DIAGRAMATIC AND ARE BASED ON ONE MANUFACTURE'S COPPETURE OF THE PLANT OF A SHIP OF THE PLANT OF A SHIP OF THE PLANT OF A SHIP OF THE PLANT OF THE PLANT OF THE COUPMENT THE CONTRACTOR SHALL KEEP'S THE ACTUAL DIMENSIONS OF THE COUPMENT PROPOSED TO ENSURE THAT THE COUPMENT PROPOSED TO ENSURE THAT THE COUPMENT WILL FIT IN THE AVAILABLES SPACE.
- D. SEAL AND FLASH ALL WALL PENETRATIONS AIR AND WEATHER-TIGHT.

8. TESTING AND DISINFECTION

A. PLUMBING SYSTEMS SHALL BE FLOW AND PRESSURE TESTED & DISINFECTED IN ACCORDANCE WITH STANDARD PRACTICE AND THE INTERNATIONAL PLUMBING CODE.

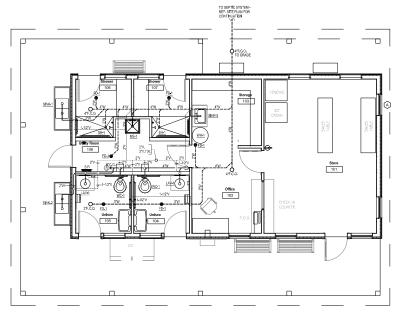

PLUMBING PLAN - WASTE & VENT

	PLUMBING :	SYMBOLS	
SYMBOL	DESCRIPTION	SYMBOL	DESCRIPTION
	- SOIL OR WASTE PIPE (BELOW GROUND)	-	VACUUM BREAKER
	SOIL OR WASTE PIPE (ABOVE GROUND)	Ø	PRESSURE GAGE
	VENT PIPE (V)	ģ	TEMPERATURE GAGE
	- COLD WATER PIPE (CW)	⊸ \$—	PRESSURE REDUCING VALVE
	HOT WATER PIPE (HW)	\$	GAS COCK
	HOT WATER RETURN (HWR)	VTR	VENT THROUGH ROOF
G	GAS PIPE	LAV	LAVATORY
sp	STORM DRAIN	wc	WATER CLOSET
── ○ FD	FLOOR DRAIN	URN	URINAL
 0 co	CLEAN-OUT(FLOOR)	4	COLD WATER CONNECTION
<u></u> — 0 co	CLEAN-OUT(WALL OR ABOVE CLG.)	₫ (120°F)	HOT WATER CONNECTION
(WH)	HOT WATER HEATER	₫ (140°F)	HOT WATER CONNECTION
->>-	GATE VALVE	∢	HOT WATER RETURN CONNECTION
-17 ⊢	CHECK VALVE	-	GAS CONNECTION
≱ ⊢	TEMP./PRESS. RELIEF VALVE	C.S.	IN CRAWL SPACE
_ -	FIXTURE ISCLATION VALVE	GV	ELECTRIC GAS VALVE FOR PIPING LINDER HOODS -
-10€0	BALL VALVE		TIE INTO ANSUL SYSTEM

MARK	DESCRIPTION	MANUFACTURER - MODEL #	ACCESSORIES & NOTES		PIPIN	G CONNE	CTIONS		COLOR & FINISH	
					TRAP S/W VENT		C.W. H.W.			NOTES
WC-1	ACCESSIBLE TOILET	AMERICAN STANDARD: AFWALL MILLENIUM FLOWISE 1.28 GPF FLUSHOMETER MCOEL: 2856.128	FILISH VALVE: AMERICAN STANDARD MODEL 6047.121.002 TOLORIES: MAY RESIDENT MERICAN STANDARD WOODEL #5901.100 CARRIES: MAY RESIMITY, DIR CUULL.	INTEGRAL	4"	2*	1"	_	MHTE	
LAV-1	COUNTER SINK	CORIAN: ADA-COMPLIANT MODEL (#810	Folicet: Symmons symmetrix $S-20-2-0.5$, trap- chadne plated, mixing valve: Symmons maxime $7-210-CK-W$, pipe covers: truebho Lav gland 2 e- 2 series	1-1/2*	1-1/2	1-1/2*	1/2"	1/2"	AS SELECTED BY ARCHITECT	
SH-1	ACCESSIBLE SHOWER	CUSTOM	SHOWER PAIN: SWAN FEF-30GU,/R VENTEK BARRIER-FREE SHOWER PAN WITH FIT-FLO DRAIN. DRIVE WITH FITO-A-2-NH-A5-7, HEILE SMAKKOK SPETMIX 4-151 (2 HEILES 6 ADJ), CONTROLS SYMMONS SWETTMIX 4-500-BC-RF, DIXERTER VALVE SHAMONS VOICE ZOW.	2*	2*	1-1/2*	1/2"	1/2"	AS SELECTED BY ARCHITECT	
FD-1	FLOOR DRAIN	ZURN: MODEL FD2-TSP-NP	TRAP SEAL: ZURN Z1072 ZSHIELD BARRIER TRAP SEAL DEVICE	2*	2*	1-1/2*	_	_		
MS-1	MOP SINK	FIAT MODEL MSB2424	FAUCET: FIAT MODEL 830AA MCP HANGER: FIAT MODEL889CC FAIT STANLESS BUMPER GUAPD	3*	3"	1-1/2*	1/2"	1/2"		
SINK-1	DISH WASHING SINK	ADVANCE TABCO MCOEL VKCT-246 WITH TA-11A-2 BOWLS AND ADJUSTABLE LEGS MOUNTED AT ACCESSIBLE HEIGHT (MOUNTED AT BARRIER-FREE HEIGHT).	FAUCET: ADVANCE TABOO HEAVY OUTY MODEL K-1118 SPASH MOUNTED FAUCETS, 8° CTRS., SMIG NOZZE, 12° SPOUT. STAINLESS STEEL STRANKER AND DRAIN BODY. PROVIDE 1 FAUCET PER EACH BOWL.	2*	2"	1-1/2*	1/2"	1/2"		
SINK-2	DISH WASHING SINK	ADVANCE TABCO MODEL VXCT-246 WITH TA-11B-2 BOWLS AND ADJUSTABLE LEGS.	 FAUCET: ADVANCE TABCO HEAVY DUTY MODEL K-1118 SPASH MOUNTED FAUCETS, 8° CITCS, SINING MOZIEL, 12° SPOUT. STAINLESS SITES STRANGEN AND DRAIN BODY. PROMDE 1 FAUCET PER EACH BOML 	2*	2"	1-1/2*	1/2"	1/2"		
SINK-3	UTILITY	ELKAY LUSTERTONE CLASSIC STAINLESS STEEL 22°X19.5°X7-5/8° SINGLE BOML DROP-IN SINK + FAUCET KIT - MODEL LR2219SC	*Fancet: included *Stanless Steel Strange and drain 800y.	1-1/2*	1-1/2"	1-1/2*	1/2"	1/2"		
NOTES:	F EQUAL OR B	CALES FIXTURES SELECTED AS THE BASIS OF DESIGN, ALTERNATIVES WILL BE ETTER QUALITY. EGESSARY TRIM AND FITTINGS REQUIRED FOR A COMPLETE INSTALLATION	3 MATER PRING SHALL BE INSTALLED TO ALLOW FOR SEASONAL DRAIN DOWN OF THE MATER SYSTEM, REVOICE DRAIN WAVES AS REQUIRED AT LOW POINTS. DRAIN WAVES SHALL BE LOCATED TO LIMIT PUBLIC ACCESS.							

CIPIB CHARLES P. BUCKLEY PROFESSIONAL ENGINEER 600 BEFOT ST. RUMNEY, N.I. OGDOGO TZL (603)786-8982 FAL(603)786-2035

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NH STATE PARKS

Campground Expansion Project PII Mollidgewock State Park 1437 Berlin Road Errol, NH 03579

1	
80%	DESIGN

Graphic Scale

Issue

North

Date: NOV. 22, 2023

Drawn By: CPB Checked By: CPB


su	98;	
ło.	Description	Date

PLUMBING PLAN AND DETAILS


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P1.01M


	WATER HEATER SCHEDULE									
WARK	CAPACITY	RECOVERY 0 100 DEG. F.	8TU PER HR.	GAS COMN.	MATER I			MANUFACTURE & MODEL	REMARKS	
		RISE		CONN.	DONN	AMPS	VOLT-PHASE	& MODEL		
WH-1	100 GAL	178 GAL./HR.	150,000	3/4*	1-1/4*	10.0	120-1	A.O. SMITH MODEL BTH 150	-PROPAGE FRED -POREN YORTO -POREN YORTO -POREN YORTO -I 40 DEG F. DISCHARGE TEMPILICENO VALVE	

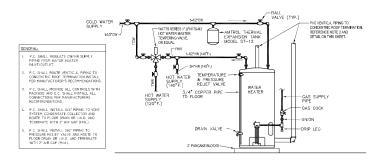


WATER HEATER WITH MIXING VALVE DETAIL

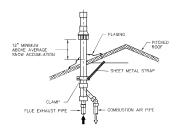


CONCENTRIC FLUE PIPING DETAIL FOR HIGH EFFICIENCY WATER HEATER

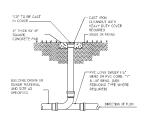

GRADE CLEANOUT DETAIL

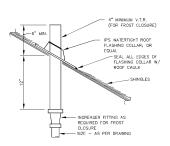


VENT THRU ROOF DETAIL

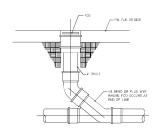


FLOOR CLEANOUT DETAIL




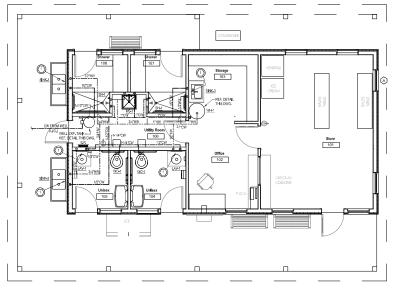

PLUMBING PLAN - DOMESTIC WATER AND GAS

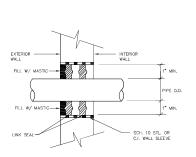

EXTERIOR WALL SLEEVE DETAIL

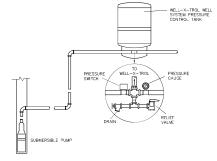

WELL SYSTEM PRESSURE CONTROL TANK DETAIL



N.H. LIC. NO. 09198



HVAC, Elec. & Plumb, Engineer: Charles P. Buckley, P.E. 500 Depot Street Rumney, NH 03266 tel: (603) 786-9992

Structural Engineer: Fisher Engineering, P.C. 686 Belknap Mountain Road Gilford, NH 03249 tel: (603) 528-7641

NH STATE PARKS

Campground Expansion Project Pil Mollidgewock State Park 1437 Berlin Road Errol, NH 03579

80% DESIGN

Date: NOV. 22, 2023


Drawn By: CPB

Date


Tite PLUMBING PLAN AND DETAILS

P1.02M

Project Number: 23045001 File:

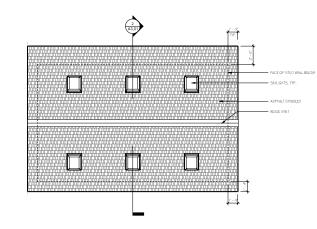

2 ROOF PLAN Scale: 1/4" = 1'-0"

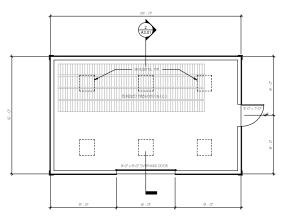

MAIN FLOOR PLAN Scale: 1/4" = 1'-0"

SE GROUP

131 Church Street Burlington, VT 05401 tel: 802.862.0098 fax: 802.865.2440 www.segroup.com

FOR REVIEW NOV. 29, 2023

NOT FOR CONSTRUCTION

SAMYN - D'ELIA ARCHITECTS, P.A.

P.O. Box 229 Holderness, NH 03245 tel: (603) 968-7133

HVAC, Elec. & Plumb, Engineer: Charles P. Buckley, P.E. 500 Depot Street Rumney, NH 03266 tel: (603) 786-9992

Structural Engineer: Fisher Engineering, P.C. 686 Belknap Mountain Road Gilford, NH 03249 tel: (603) 528-7641

NH STATE PARKS

Campground Expansion Project PII Mollidgewock State Park 1437 Berlin Road Errol, NH 03579

80% DESIGN

Scale: 1/4" = 1'-0"

Date: Nov. 29, 2023


Drawn By: MR Checked By: WD

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No.	Description	Date				

WOODSHED - FLOOR & ROOF PLANS


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A1.01

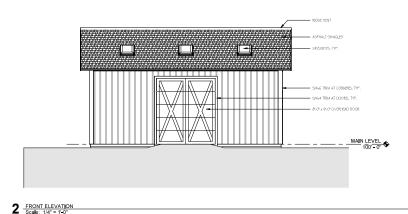


MAIN LEVEL 100°-0°

RIGHT ELEVATION
Scale: 1/4" = 1'-0"

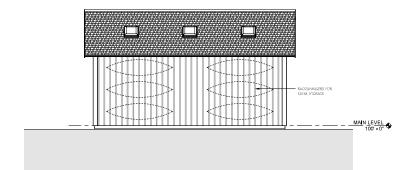

4 REAR ELEVATION
Scale: 1/4" = 1'-0"

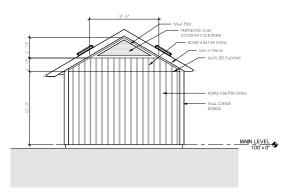

3 LEFT ELEVATION Scale: 1/4" = 1'-0"

SE GROUP

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Burlington, VT 0540 tel: 802.862.0098 fax: 802.865.2440 www. segroup.com

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NH STATE PARKS

Campground Expansion Project PII Mollidgewock State Park 1437 Berlin Road Errol, NH 03579

Issue

80% DESIGN

Graphic Scale

....

Scale: 1/4" = 1'-0"

Date: Nov. 29, 2023

Drawn By: MR
Checked By: WD


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WOODSHED - EXTERIOR ELEVATIONS


Sheet Number:

A2.01

oject Number: 2136

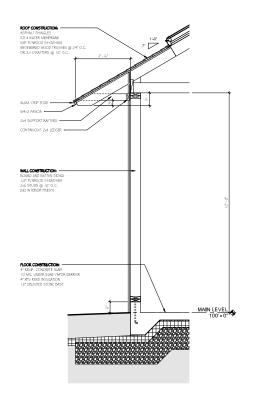

WALL SECTION
Scale: 3/4" = 1'-0"

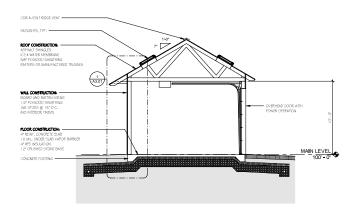

2 BUILDING SECTION - SHALLOW FOUNDATION Scale: 1/4" = 1-0"

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NH STATE PARKS

Campground Expansion Project PII Mollidgewock State Park 1437 Berlin Road Errol, NH 03579

80% DESIGN

Scale: As indicated

Date: Nov. 29, 2023


Drawn By: MR

No.	Description	Date
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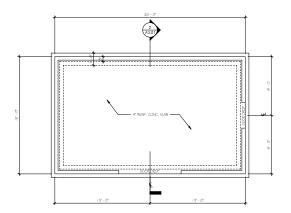
WOODSHED - SECTIONS

Sheet Number:

A3.01

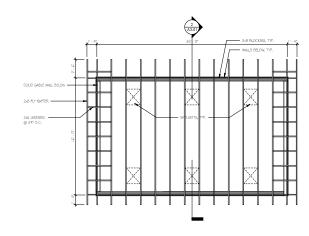

2 ROOF FRAMING PLAN Scale: 1/4" = 1'-0"



FOUNDATION PLAN
Scale: 1/4" = 1'-0"

SE GROUP

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NH STATE PARKS

Campground Expansion Project PII Mollidgewock State Park 1437 Berlin Road Errol, NH 03579

80% DESIGN

Scale: As indicated

Date: Nov. 29, 2023


Drawn By: MR

No.	Description	Date			

WOODSHED - FOUNDATION & ROOF FRAMING PLANS & DETAILS

Sheet Number:

S1.01

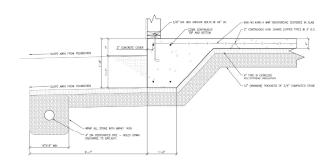

3 FOUNDATION DETAIL
Scale: 1" = 1'-0"